


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- 0.1 Exhibit Plan
- 0.2 Exhibit Gallery Plan
- 0.3 Wall Location
- 0.4 Reflected Ceiling Plan
- 0.5 Overall Wall Elevation
- 1.0 Introduction Area
- 1.1 Touchable Map
- 1.2 Hidden Wonders Wall
- 1.3 Hidden Wonders Flip Up Panels
- 2.0 Area 2.0 Geology
- 2.1 Geology
- 2.2 Details
- 2.3 Aquifer Interactive
- 2.4 Aquifer Interactive
- 3.0 Area 3.0 Uplands
- 3.1 Uplands Elevations
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- 4.0 Area 4.0 Wetlands
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- 5.1 Elevations and Details
- 5.2 Cedar Water Interactive
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- 6.0 Pinelands Resources
- 6.1 Elevations
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- 6.3 Object Reference Key
- 6.4 Graphic Rail Details
- 7.0 Map Graphic
- 7.1 Video & Frame Details
- 8.0 General Details
- 8.1 Renderings

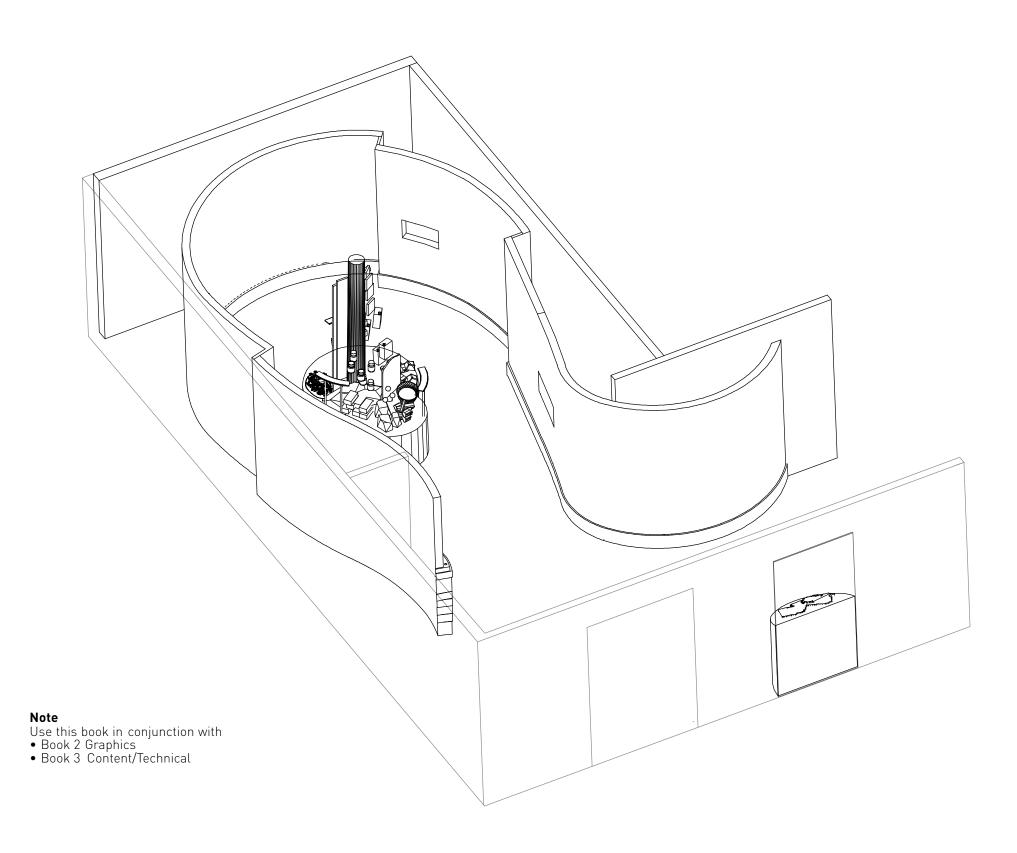

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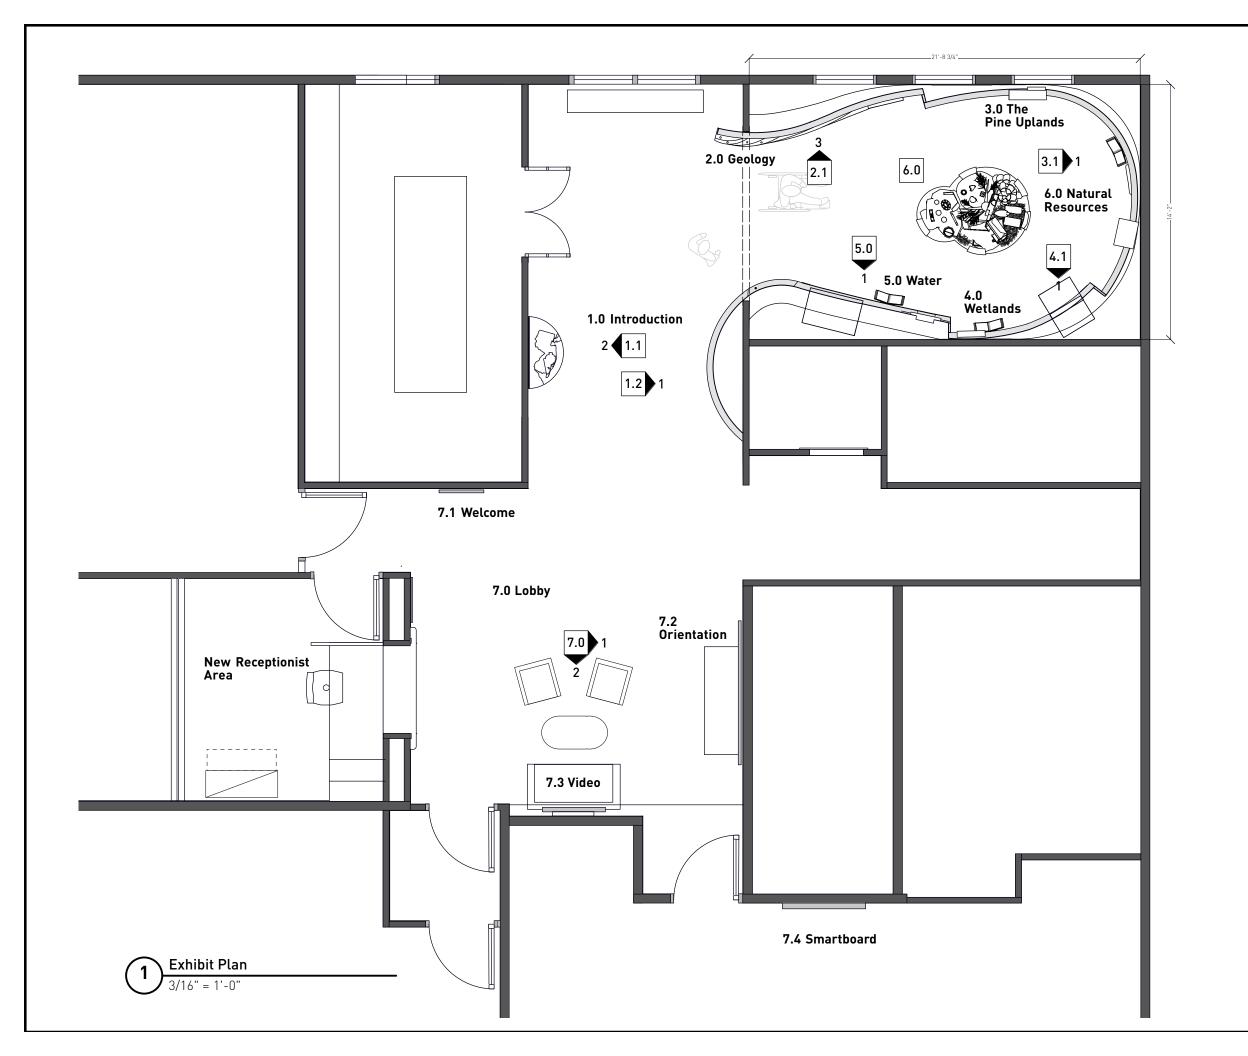
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2.15.12 Task 3

5.31.12 Task 4

Drawn by:

Table of Contents



- 4.1-1 The Wetlands
- 6.0 Natural Resources
- 7.0-1 Graphic Panel

Elevation Key Sheet-Detail

- 1.1-2 Touchable Map
- 1.2-1 Flap Interactive Wall
- 2.0-1 Geology
- 3.1-1 The Pineland Uplands
- 5.1-2 Surface Waters

- 7.0-2 Screen

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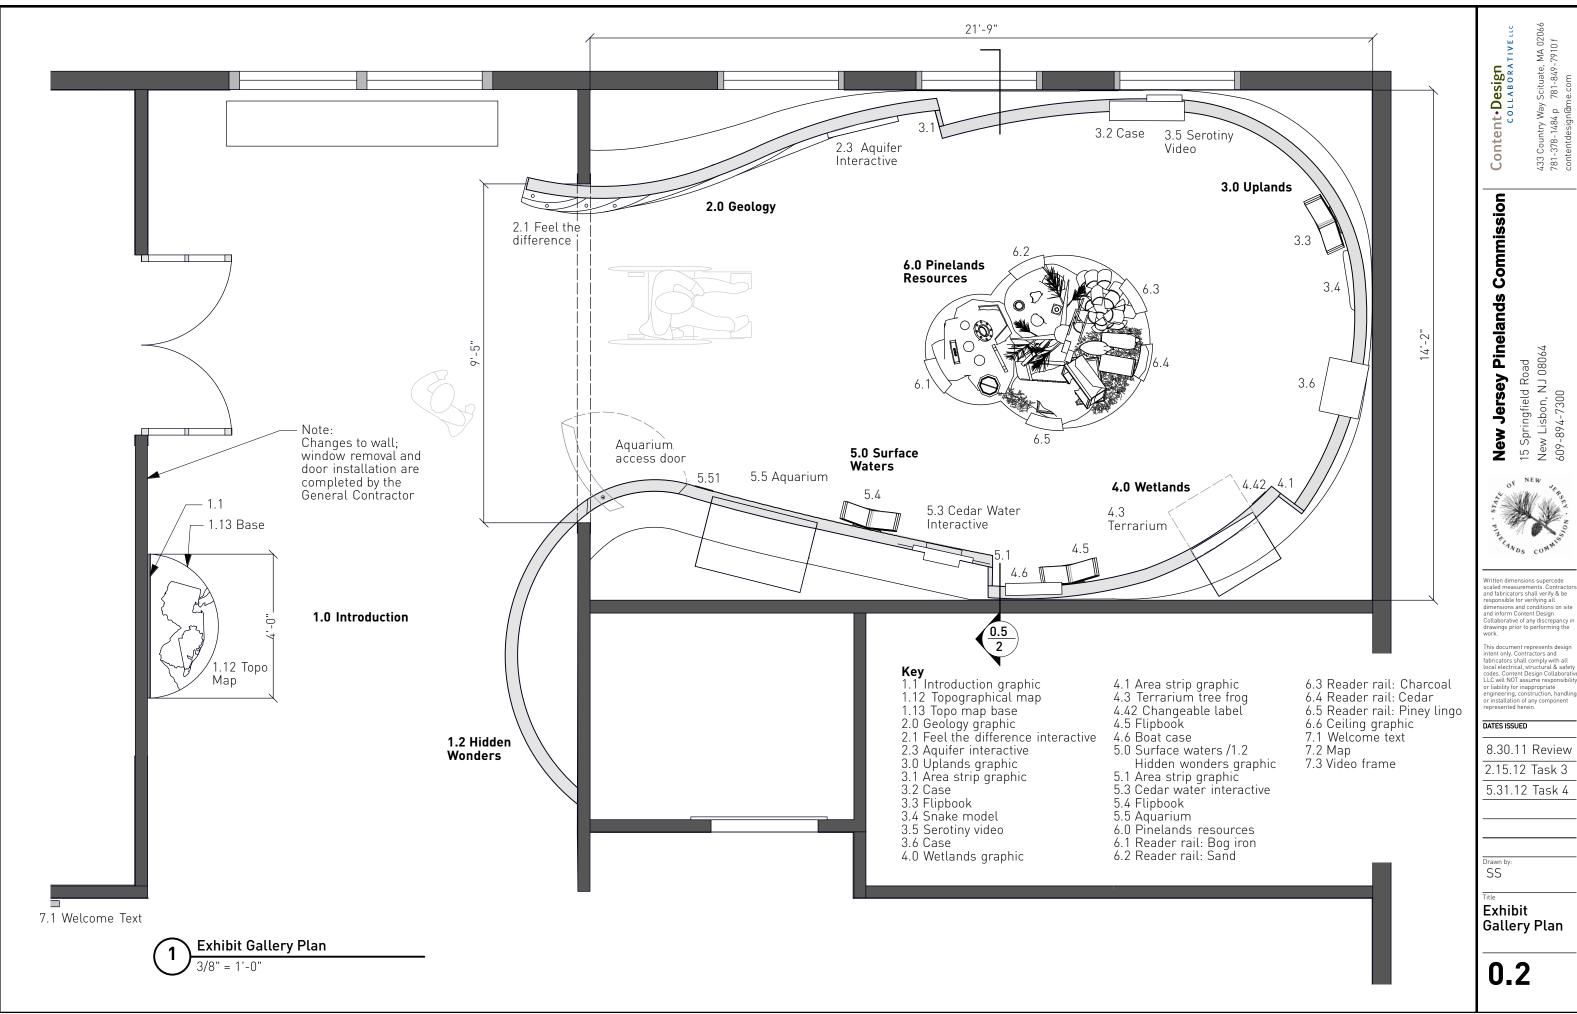
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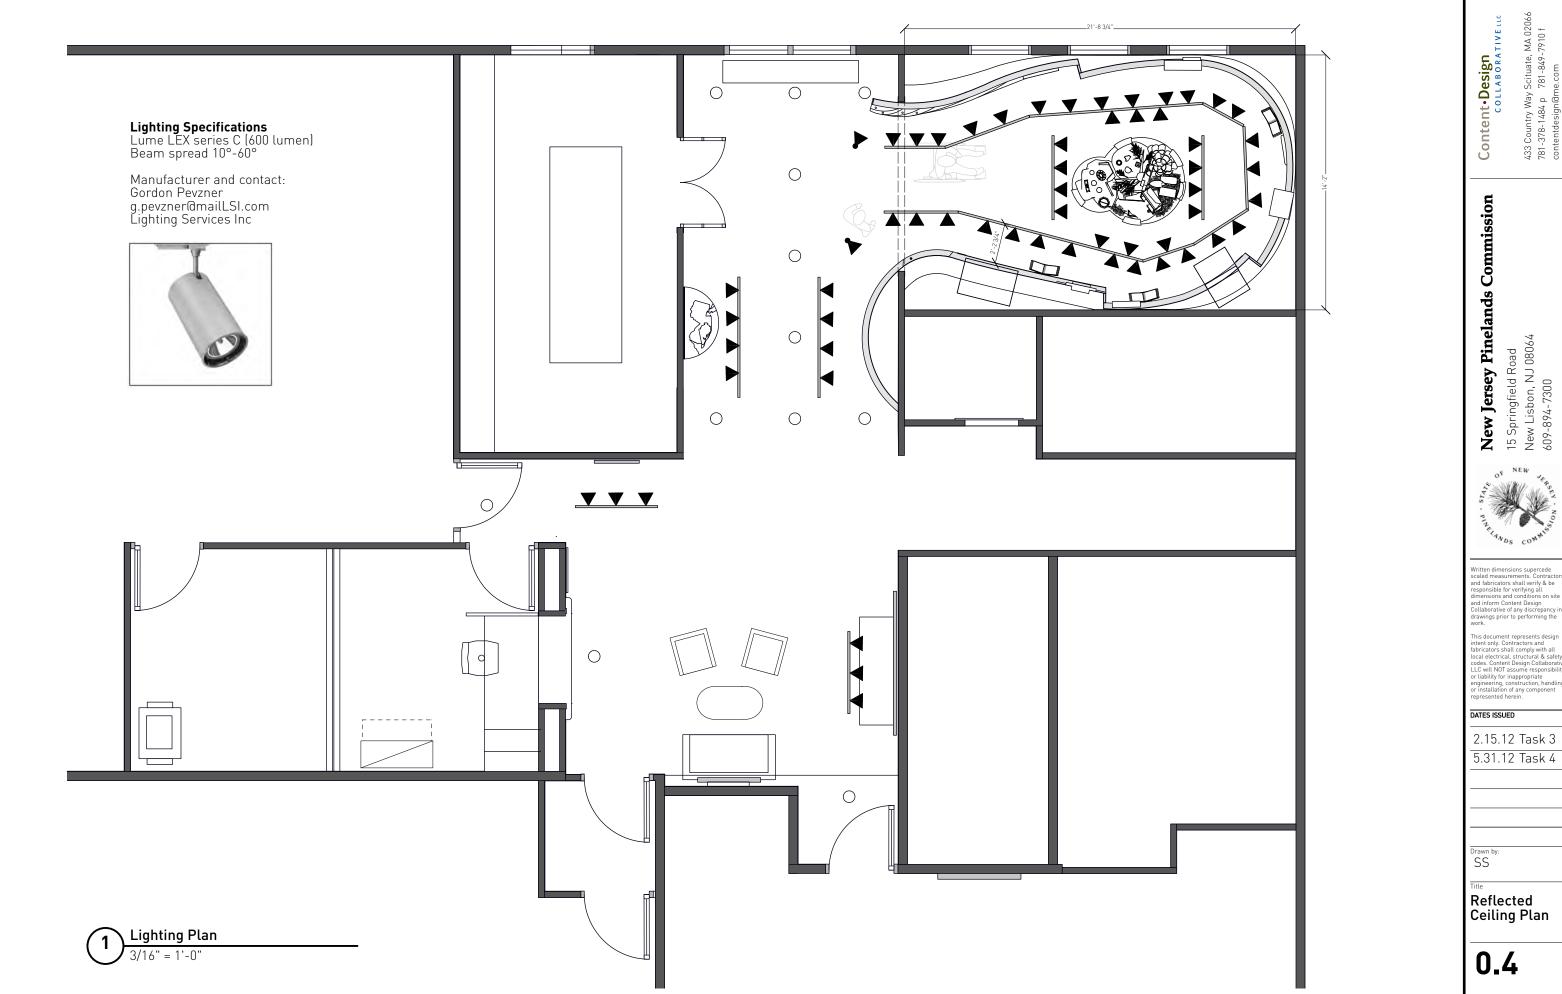
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Exhibit Plan




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Wall Location



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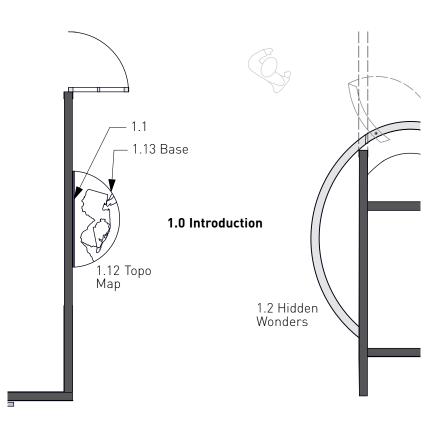
6.18.12 Update


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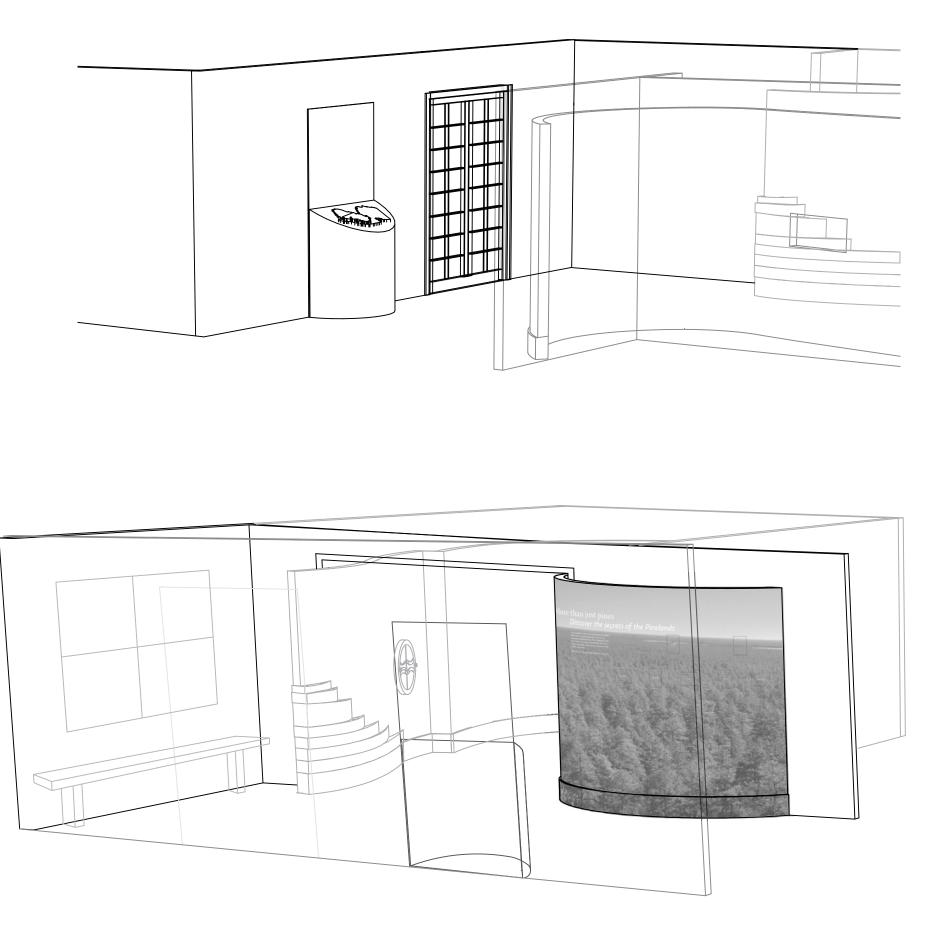
Wall Elevation

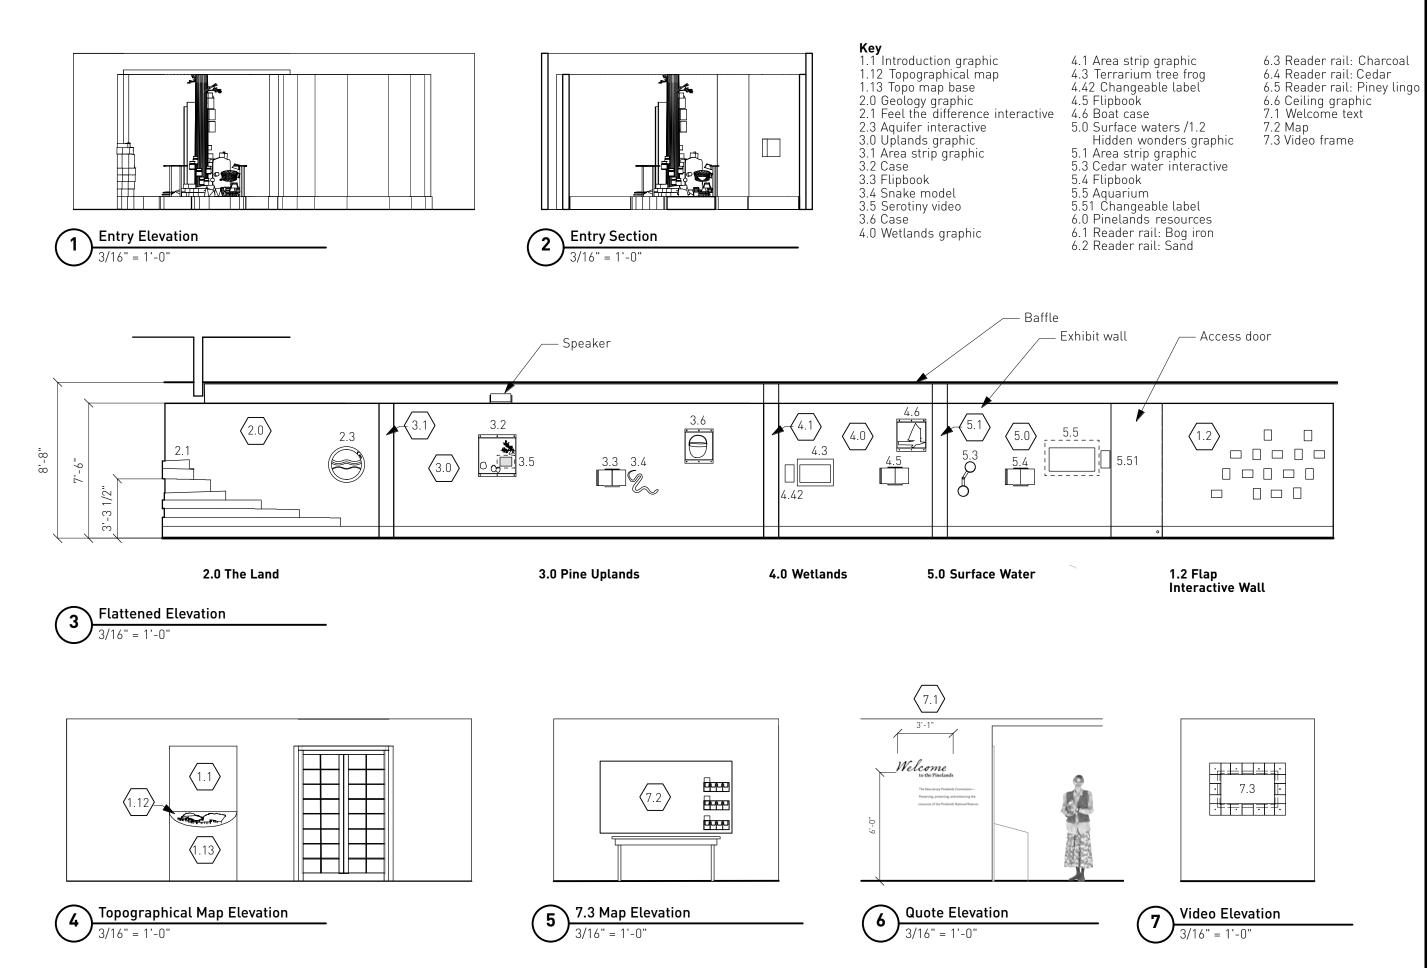Area 1 Introduction

There are two components in this area: 1.1 Introduction, a combination of graphic panel and tactile topo map, and 1.2 Hidden Wonders, a curved graphic mural wall with 16 horizontally opening flaps built into the wall. The flaps must be durable, quiet, and must return from open to close position automatically. We recommend a cord and weight type system. The topo map will be provided by a company Solid Terrain Modeling in California or equivalent.





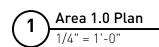

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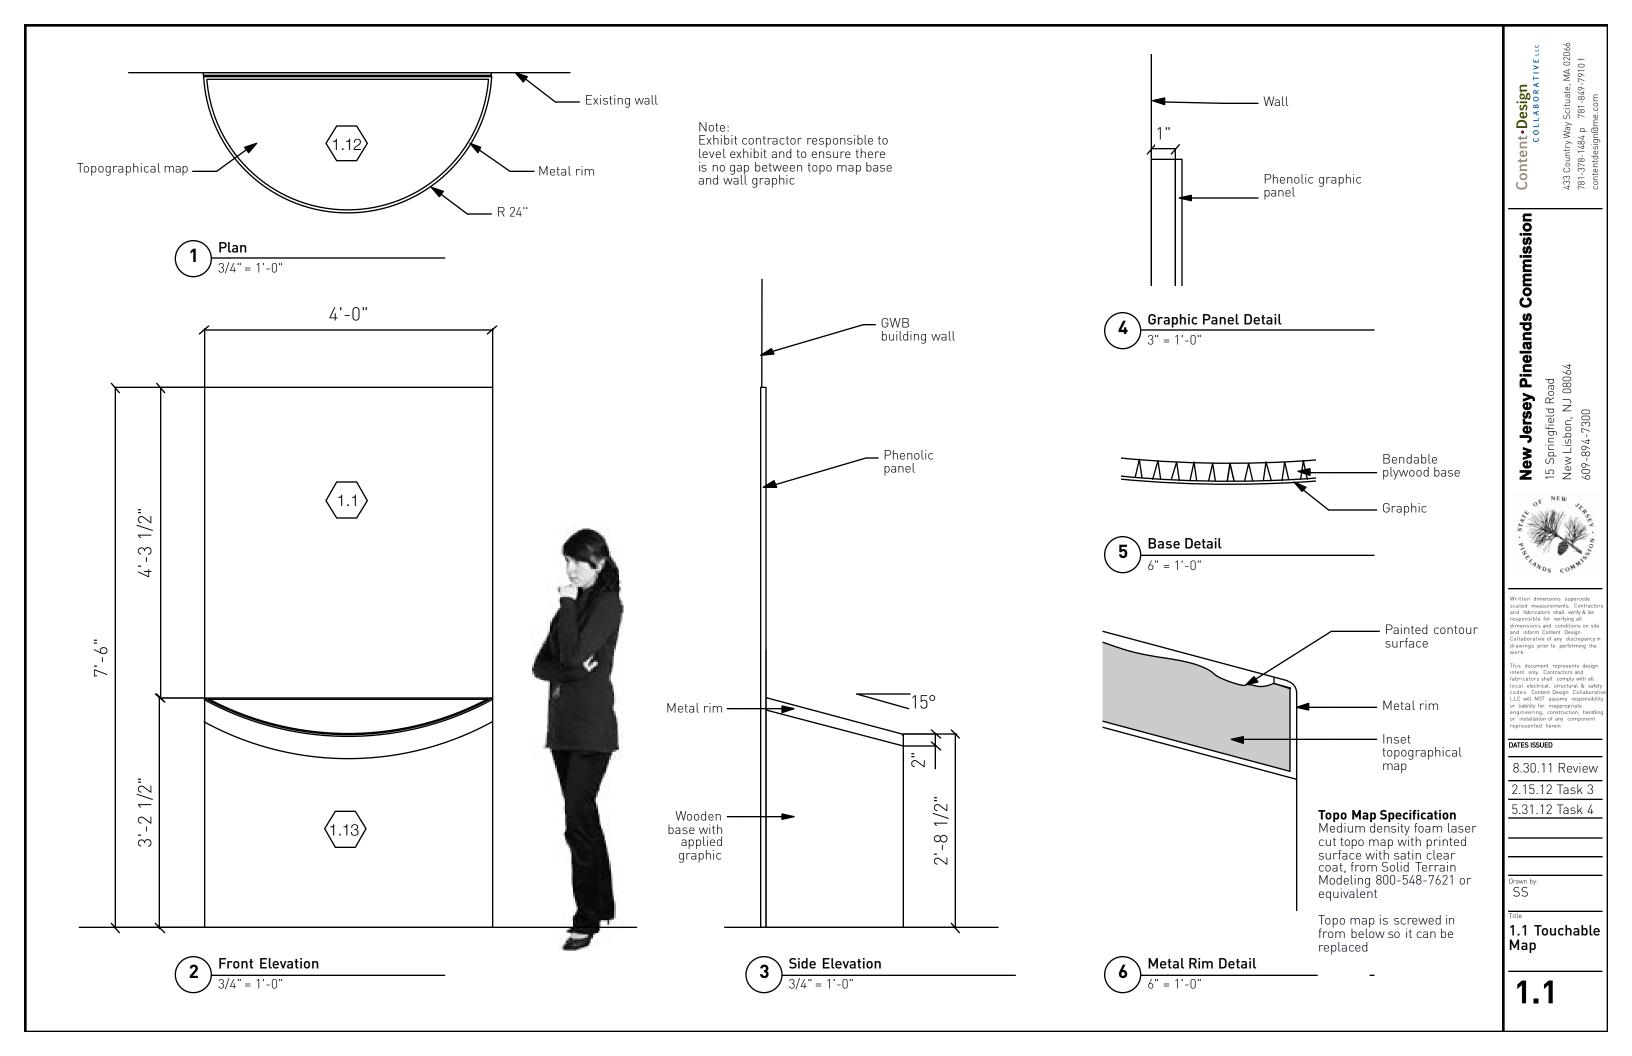
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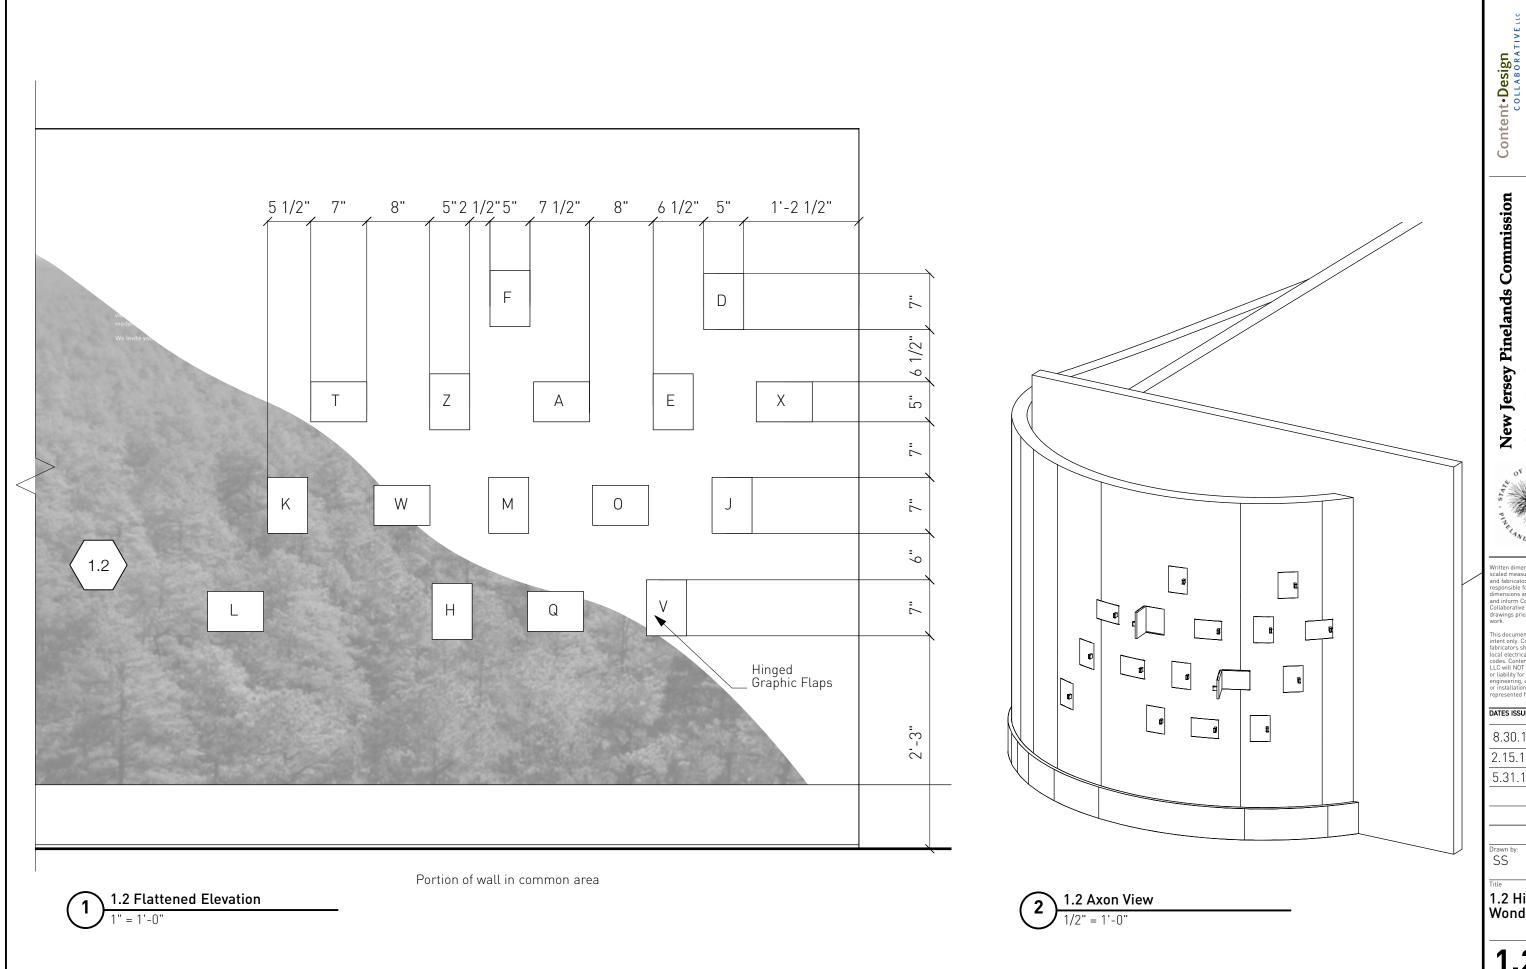
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1.0 Introduction Area





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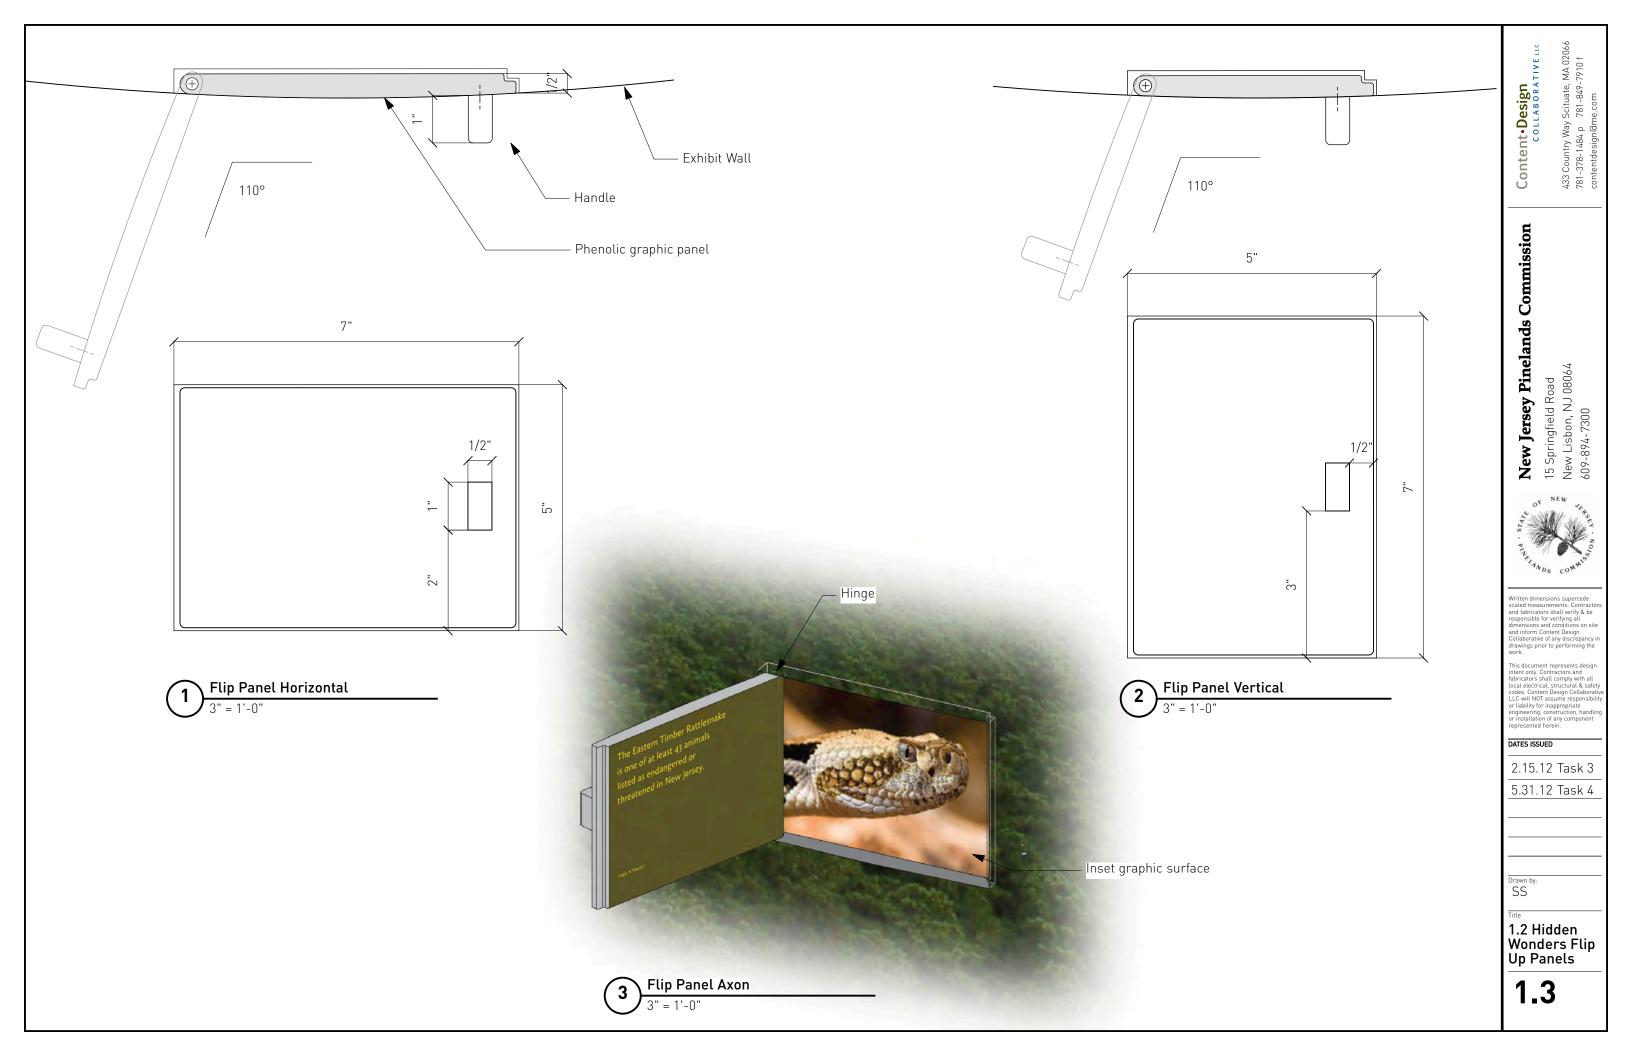
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1.2 Hidden Wonders Wall



Area 2 Geology


This area is made of four components: the exhibit wall, sand and gravel cases, scenic (painted) wall sections, and aquifer interactive. The sand and gravel cases are filled with actual sand and gravel from the Pinelands that has been disinfected. The aquifer interactive contains acrylic sand, polished stone and other material to simulate the action of water being absorbed by the aquifer. During the prototype phase, the use of actual materials can be investigated. It is not intended to visually duplicate the strata, but to evoke the idea. The liquid being used to simulate water will have bromide or other disinfectant added for stability.

Submittals

The Exhibit Contractor must create a prototype that can be used by the NJ Pinelands Commission for testing with school groups. It can be a table top version but must be similar in scale and will be used to test the interactive process.

The intention of the rubber ring at the touch hole is to remove any sand that adhered to the visitors finger tip. The entire structure is removable for filling with new sand or gravel as needed.

In addition to the submittals above, see the graphics schedule for graphics submittals and shop drawings that will be submitted.

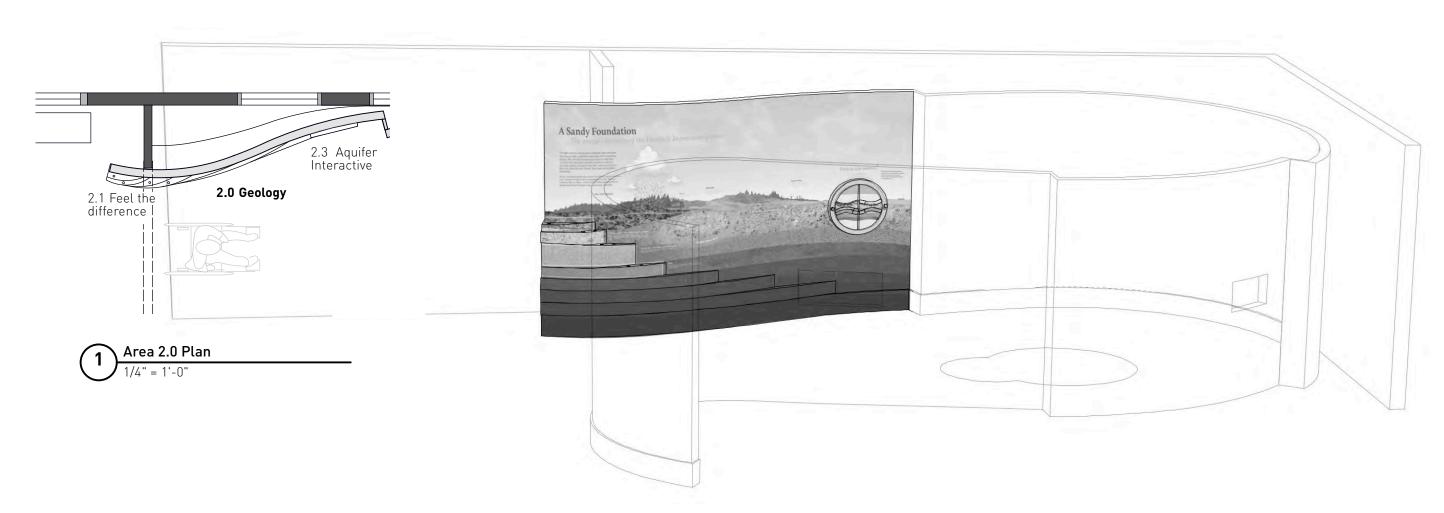

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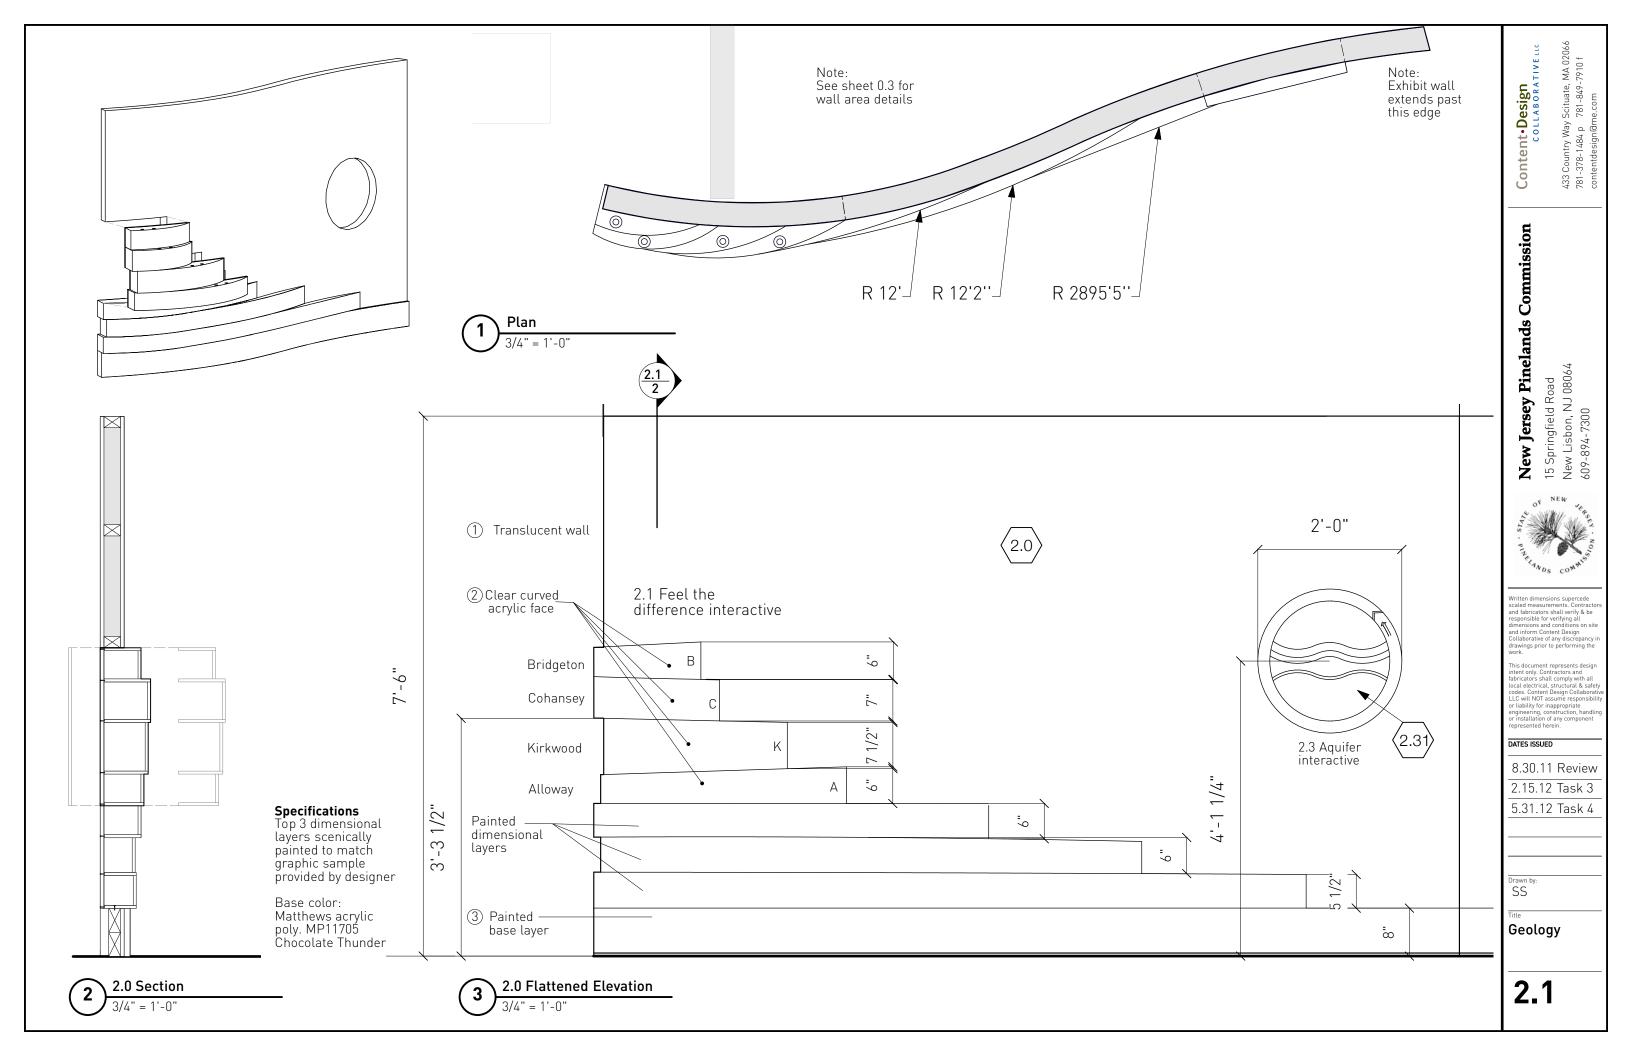
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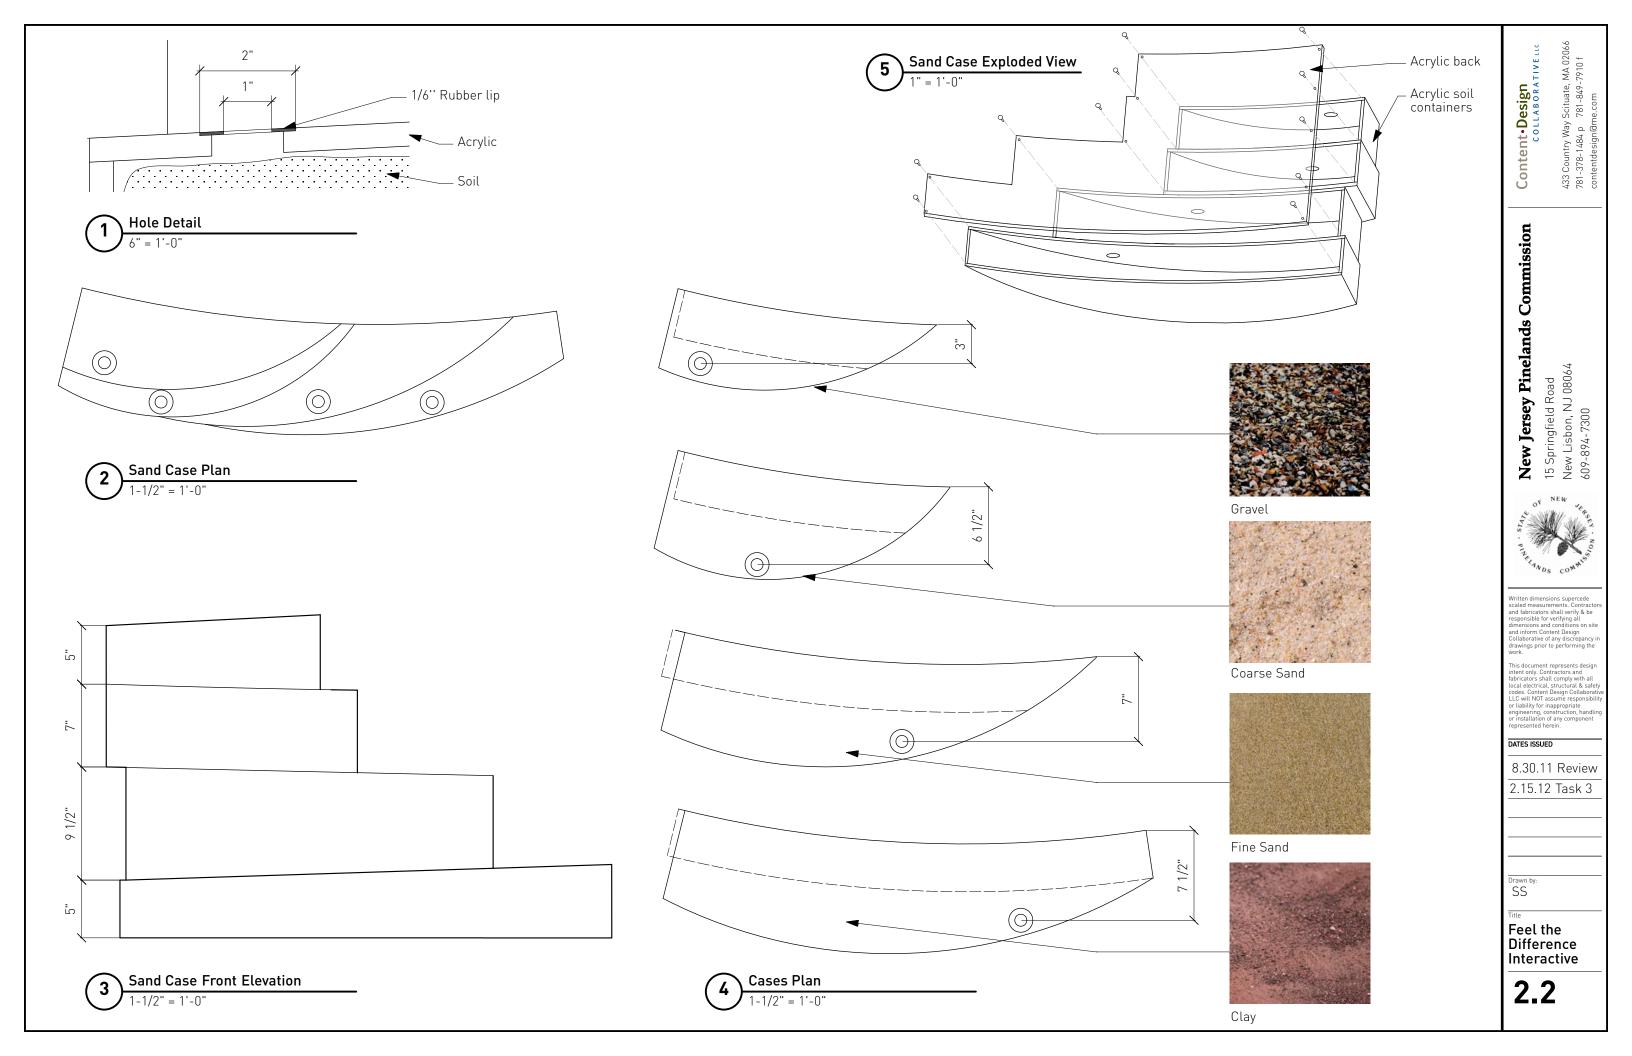
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Area 2.0 Geology






Pump motor is actuated and forces water from lower reservior to upper reservior where is begins to 'rain' upon the Pinelands

- Rainfall fills the Pinelands, between 1 quart and 2 quarts of blue-tinted, bromide treated water
- Water is slowly absorbed by the aquifer

Once water is absorbed it is visible contained in the aquifer until button is pushed to restart the cycle.

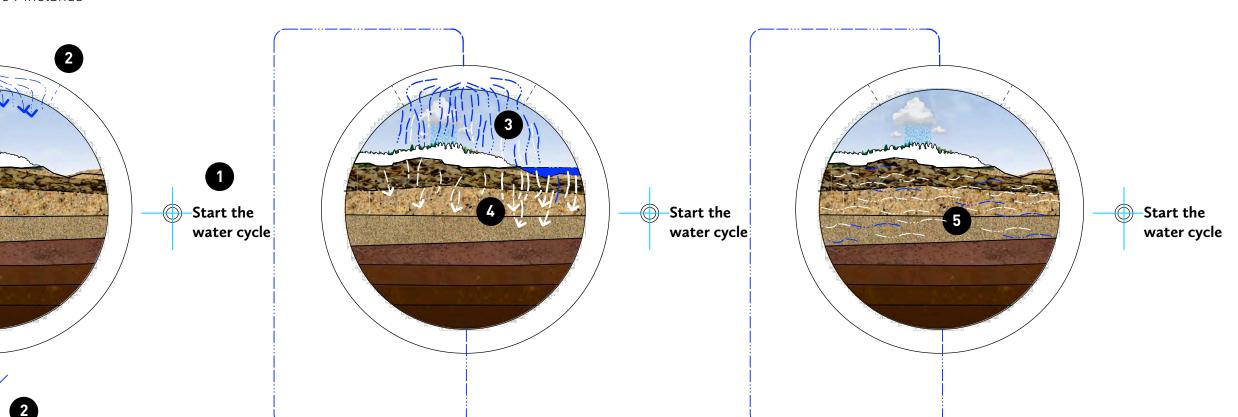

Specifications

Sand and gravel is synthetic or polished and discinfected sand and gravel.

Synthetic or natural sand and gravel color should match actual sand and gravel used in adjacent tactile exhibit as close as possible.

Back wall has graphic that is the same as the mural wall graphic.

Pump must be located in a ventilated and sound proof enclosure and must use the building power supply.

Pump is a typical aquarium pump similar to a lwaki WMD-30RLXT Pump

Aquifer interactive enclosure is metal with a 2 part Matthews acrylic polyurethane or equal.

Acrylic is an abrasion resistant type, Exhibit Contractor must provide recommended cleaning instructions to prevent accidental surface wear due to improper cleanser use.

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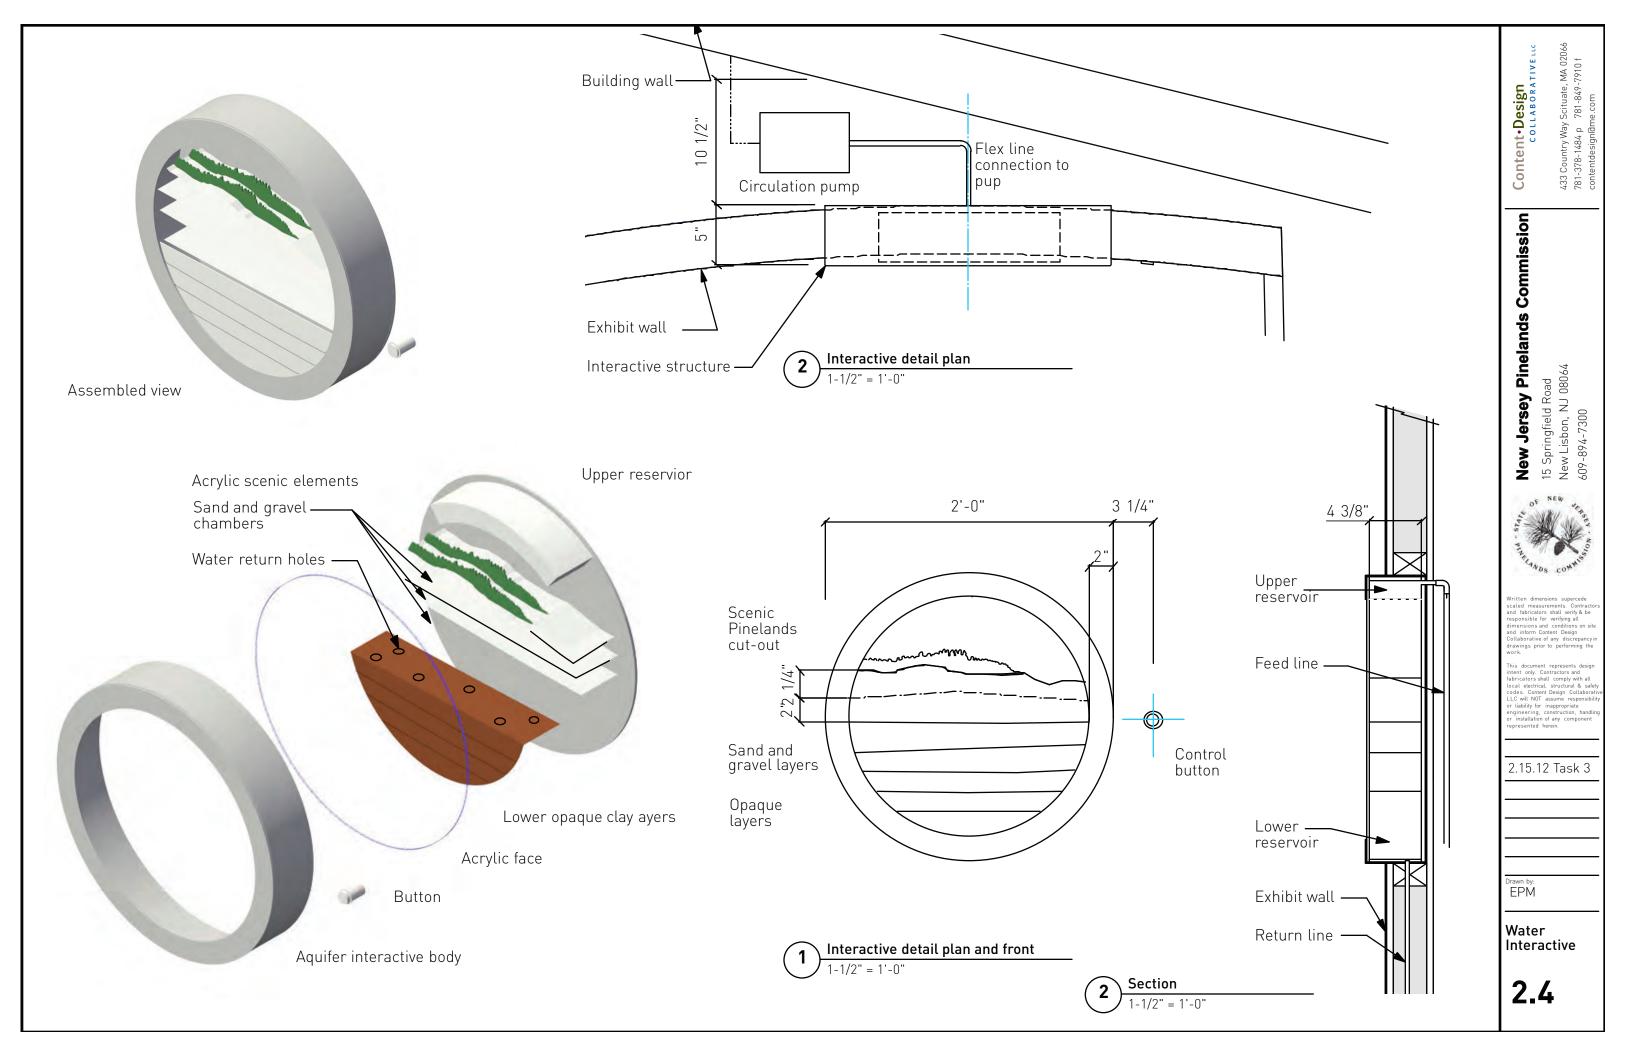
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Drawn by:

Aquifer Interactive



Area 3 Uplands


This area consists of an exhibit wall, two artifact cases that are partially protruding from the wall, with one of the cases containing a small embedded video, a flip book structure mounted directly to the wall, and finally a snake artifact also mounted directly to the wall. The audio is located in the suspended ceiling above. The mural exhibit wall has a large base that is a continuation of the base on Area 2, and has a baffle area that provides an environmental infill between the top of the exhibit wall and the room ceiling.

Submittals


There are no special submittals for this area. See the graphics specifications for information on the media component and shop drawings.


Coordination

The exhibit contractor is responsible for the continuous loop video and ambient audio as well as confirming the correct alignment of graphics and casework.

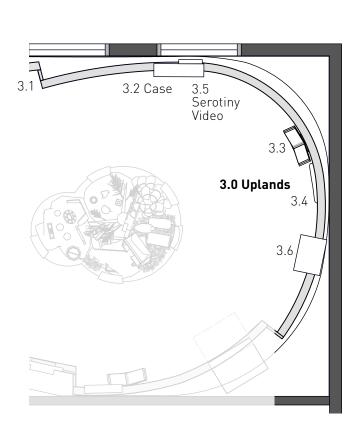



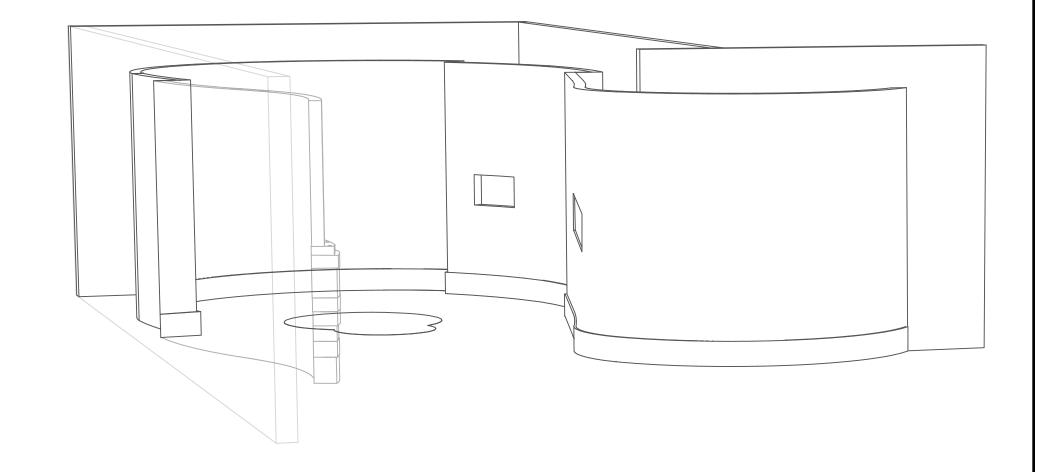

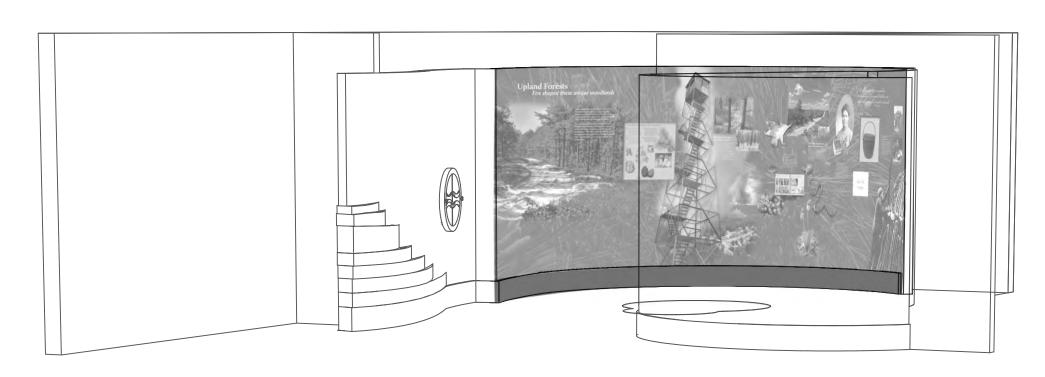

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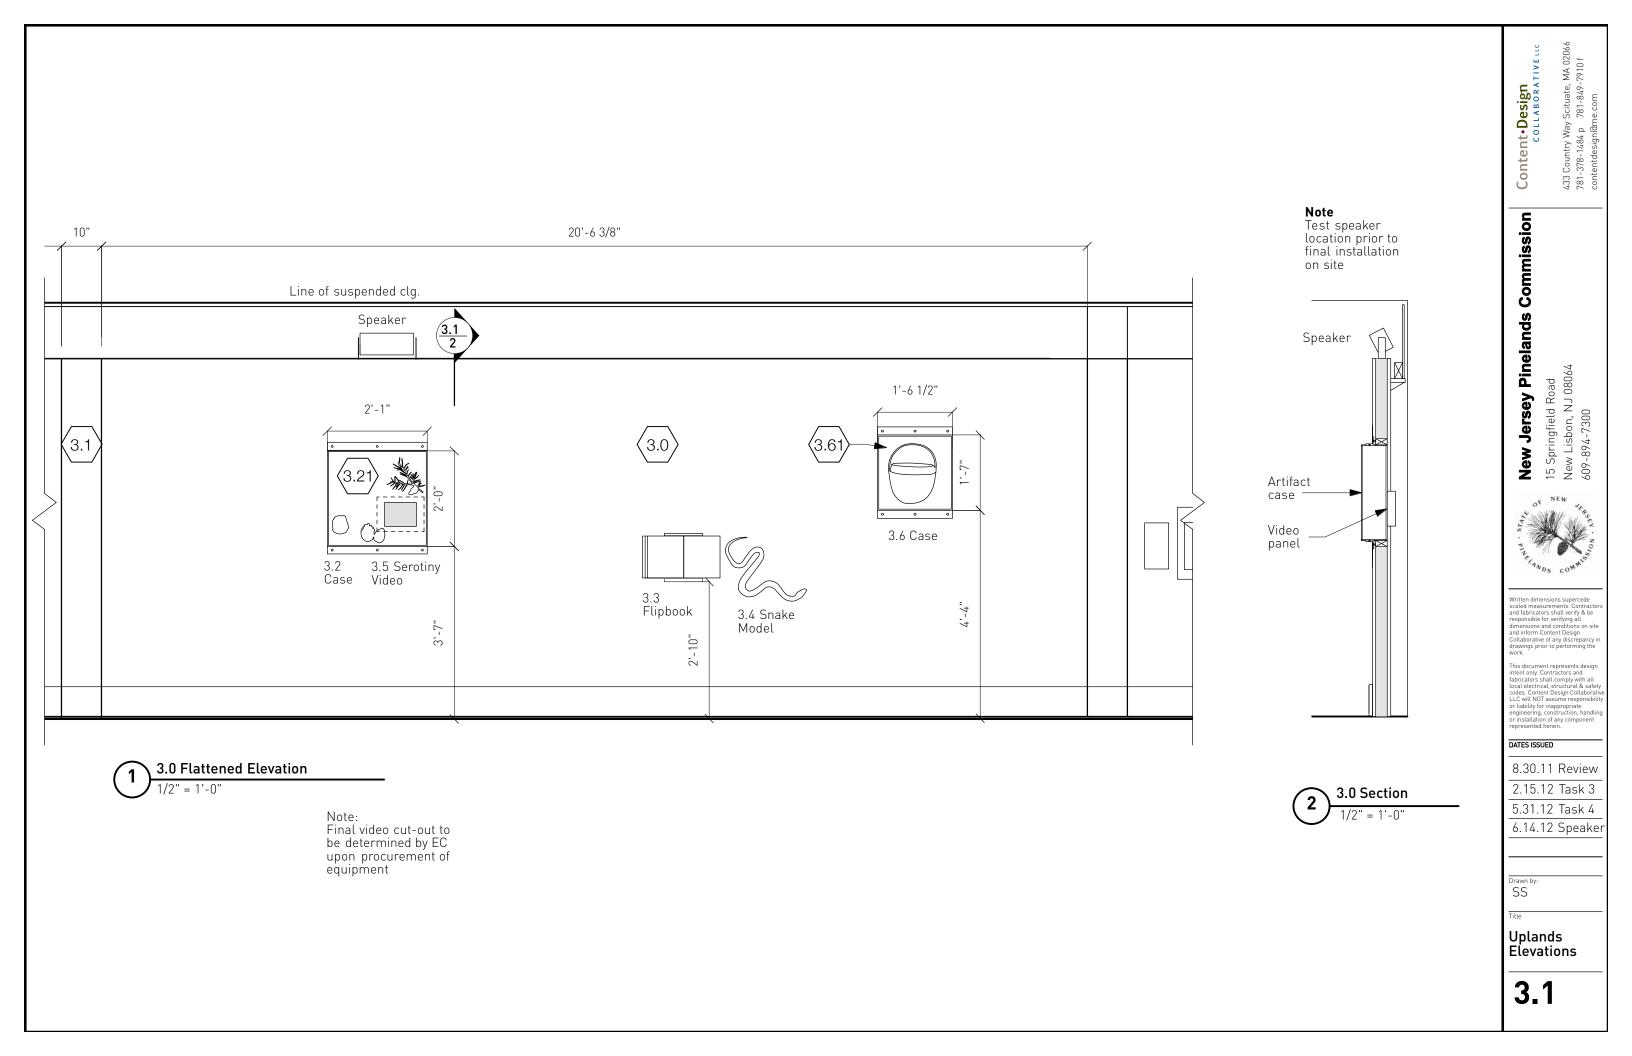
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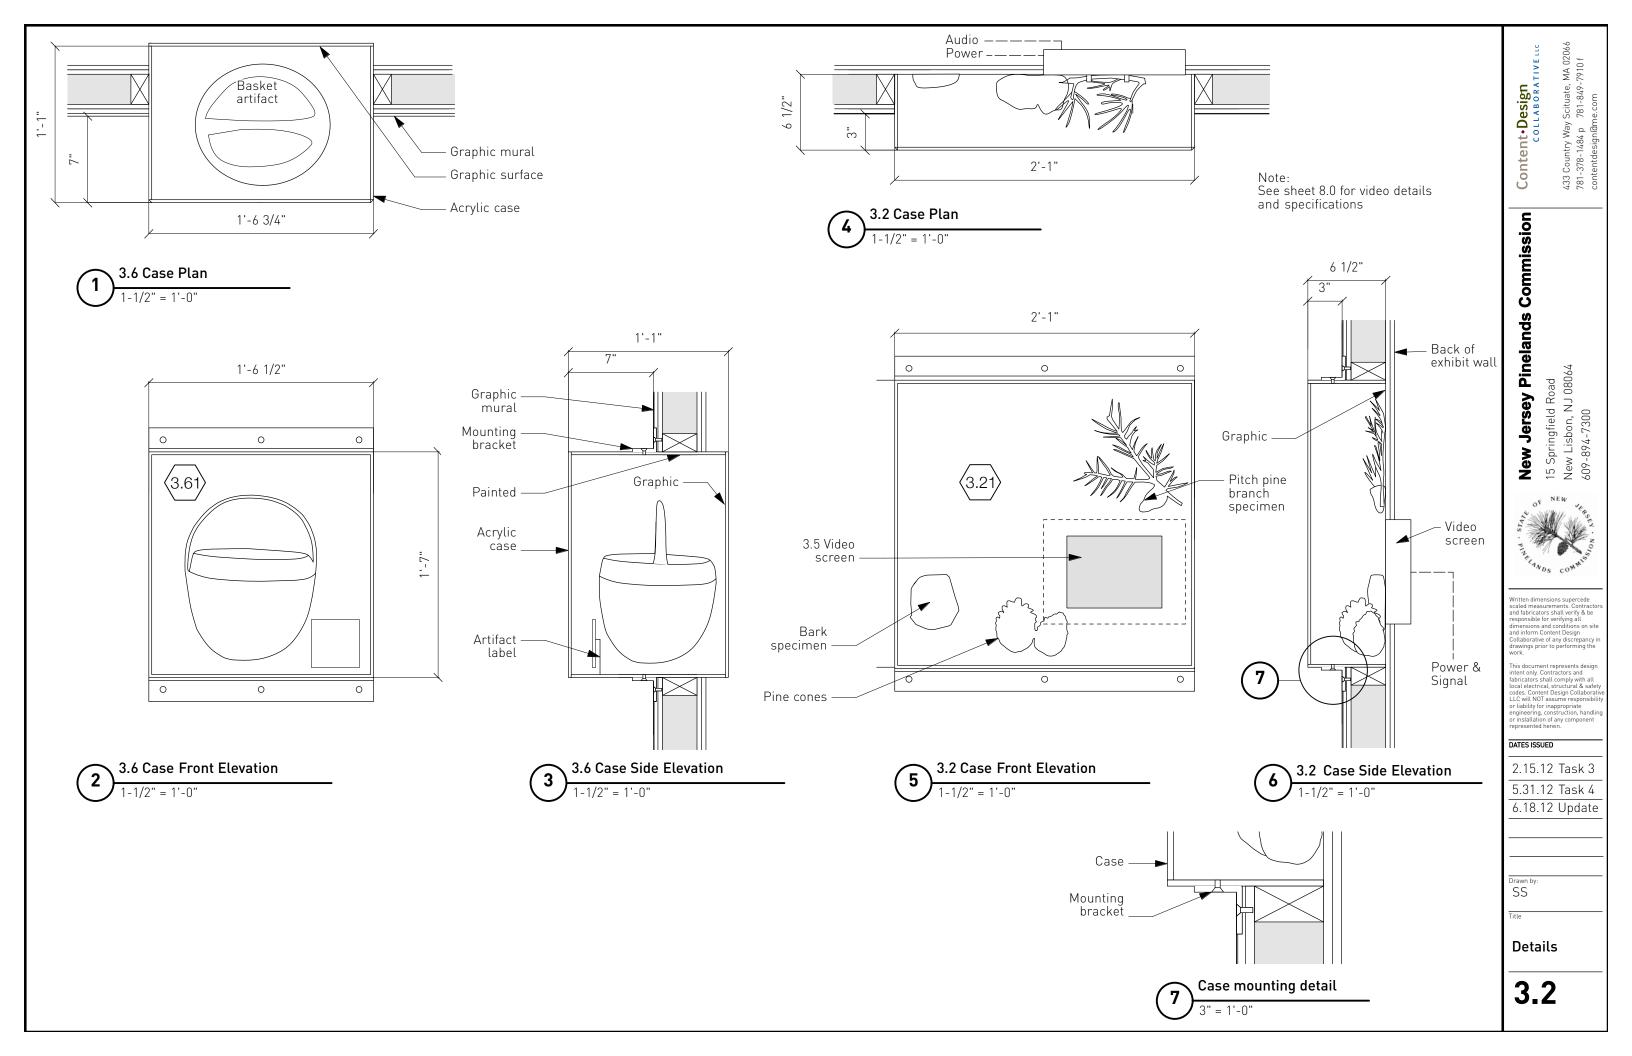
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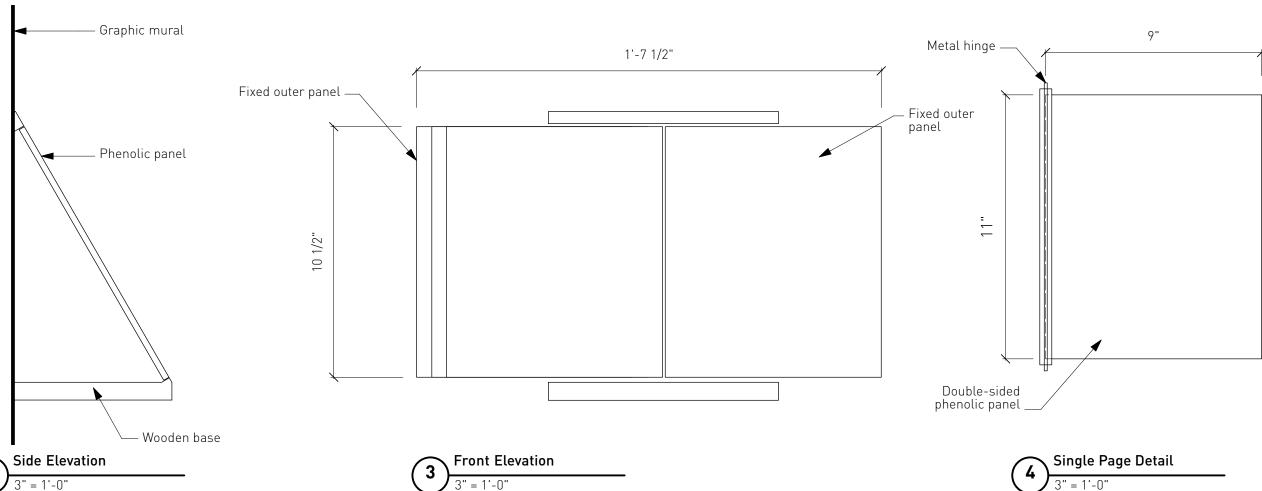
Drawn by:

Title

Area 3.0 Uplands







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Flipbook

Area 4 Wetlands


In addition to the exhibit wall with base and mural graphics, there is a surface mounted case with a half model of a Barnegat Bay sneakbox with sail. In addition, there is also the typical flip book structure and a terrarium (from Showcase cages) mounted on a slide-out system. The terrarium has a bezel frame that is removable for access. A label will be provided for mounting and placement next to the terrarium. A graphic panel is also provided that covers the terrarium opening in the event that there is no species available. The terrarium and model are provided by the exhibit contractor.


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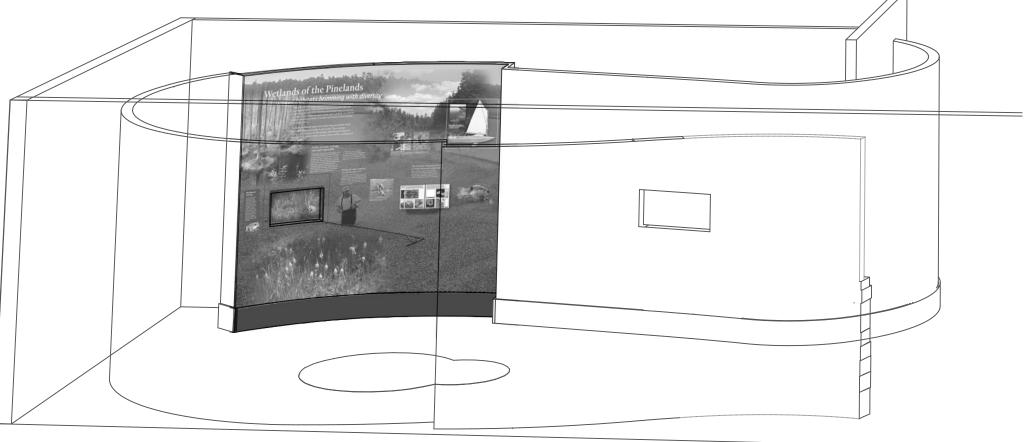
There are no special submittals for this area. See the graphics specifications and provide shop drawings.

Coordination

The exhibit contractor is responsible to ensure the artifact case and model are the correct size, as well as confirming the correct alignment of graphics and casework.



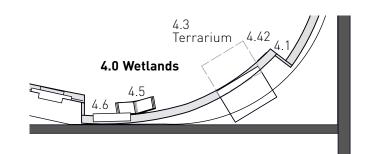

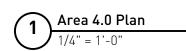

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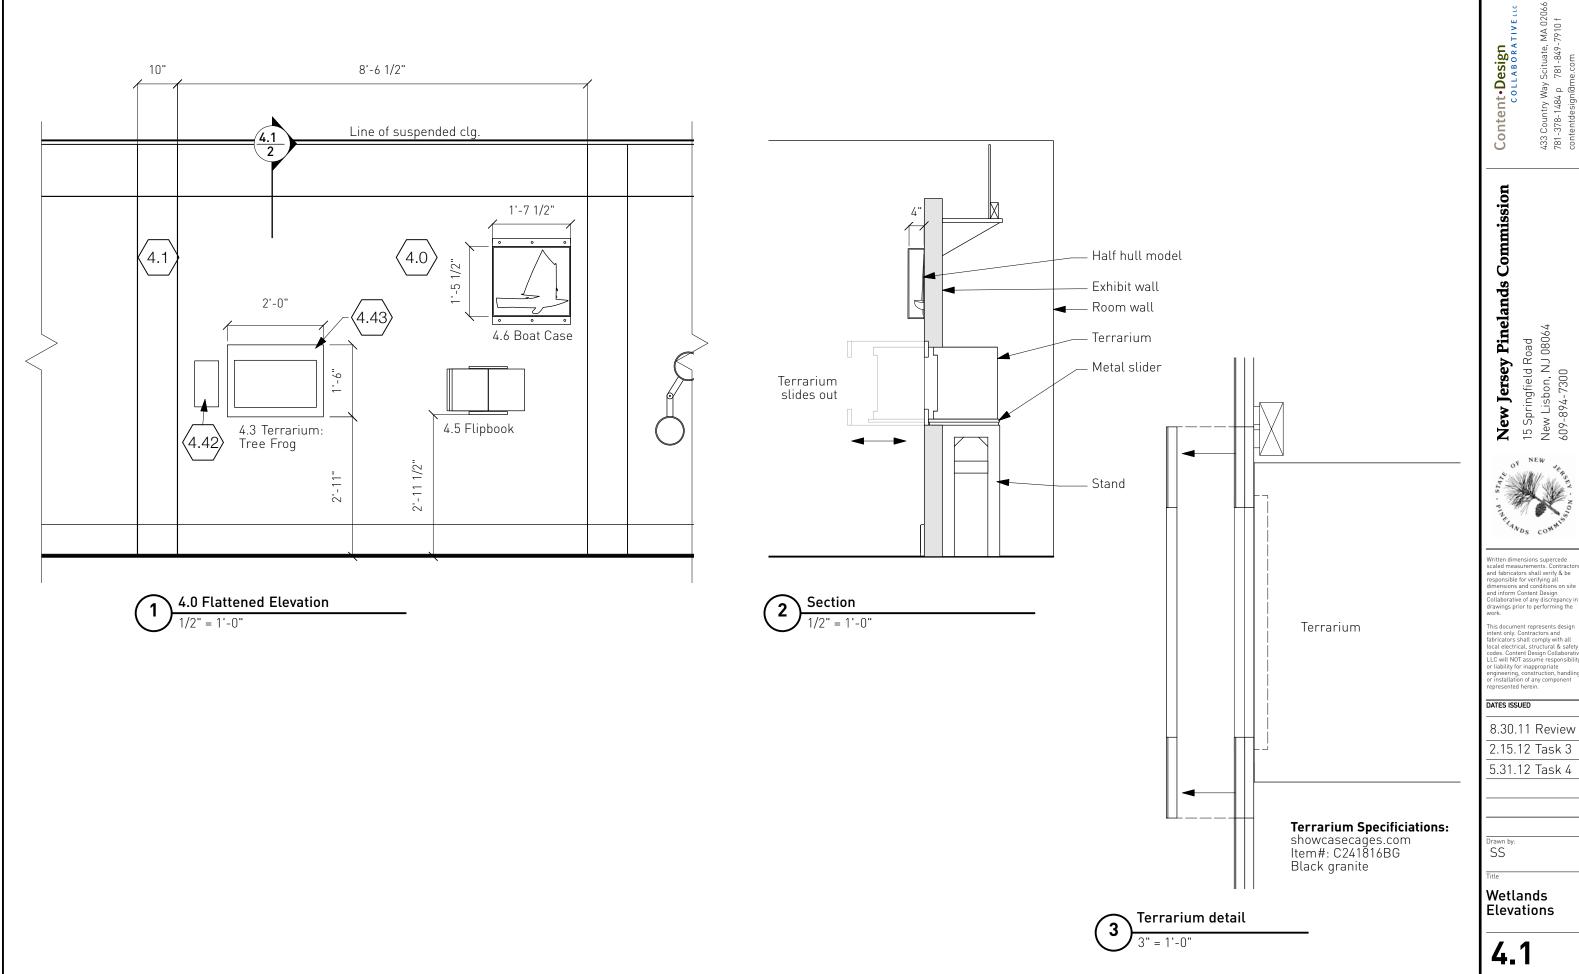
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Area 4.0 Wetlands



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Area 5 Surface Waters


In addition to the flip book, cedar water interactive, and exhibit wall graphics, embedded in the graphic mural is an aquarium, with an access door to to the right of it. This typical 'stage set' door is designed with angled inside door frame faces and a pivot hinge for minimal gap between door and mural. The door continues the graphic wall mural, and is locking. The exhibit contractor is responsible for the proper alignment of the aquarium with the face of the mural, the support for the aquarium, and the utility light. Power and water will be provided, it is not a plumbed aquarium. A lable will be provided for mounting and placement next to the aquarium.

Submittal


There are no special submittals for this area, see the graphics specifications for information on the media component and shop drawings.

Coordination

The exhibit contractor is responsible to coordinate the aquarium opening and access door swing with the room structure.

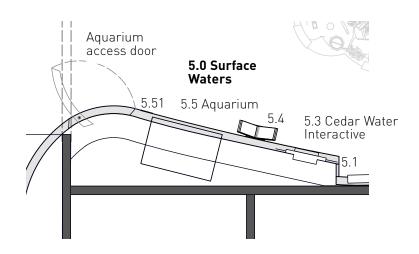



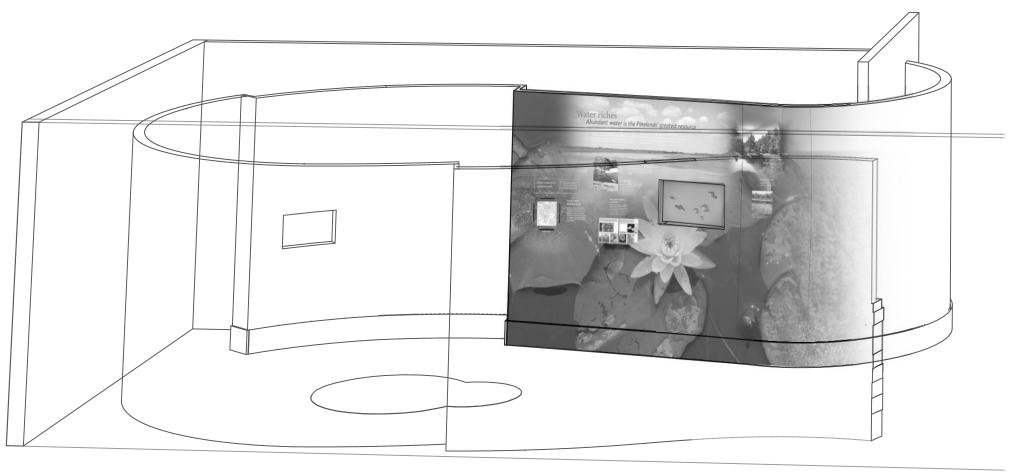

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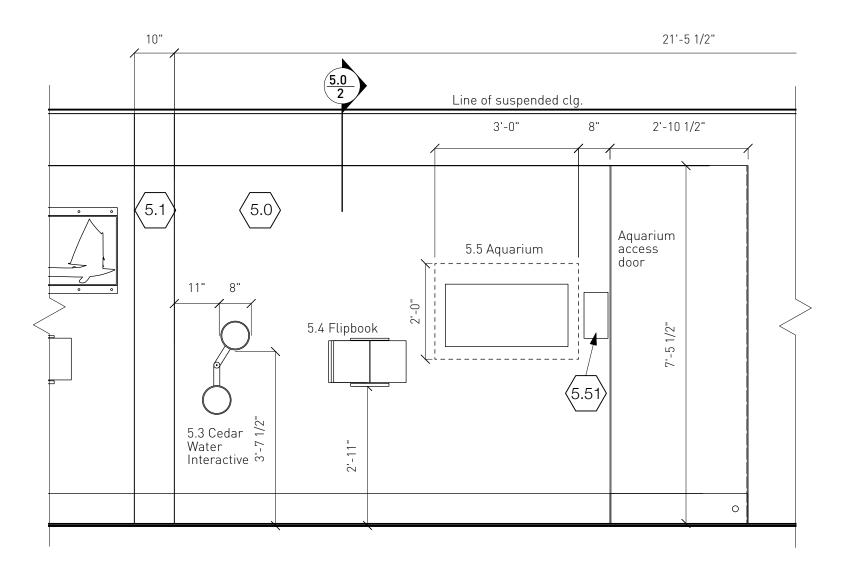
Area 5.0 Surface


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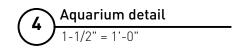
Waters


Aquarium Access Door Plan


5.0 Flattened Elevation





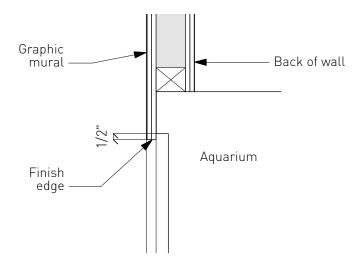

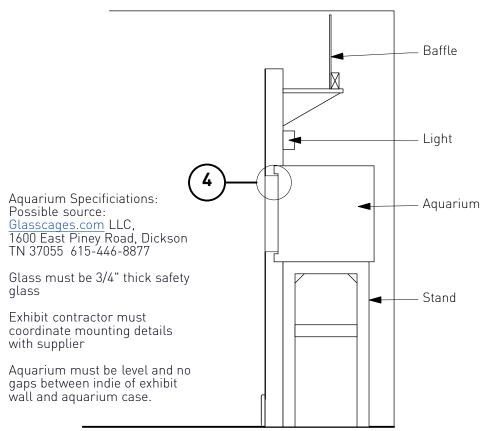

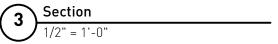

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5.0/1.2 Elevations & Details

3 1/2" Sequence 1. Position yourself in front of the viewing frame so you can see through to the gray section of the water graphic. 4 1/2" 2. Place the correct color wands behind the frame so that the color of the gray section of the graphic now matches the rest of the water color. Viewing frame Color Wand Viewing Frame Plan 4 1/2" Painted window 1/2" 1/2"3/8" frame 1'-7 1/2" 1/2" $\frac{1}{\infty}$ 9 Rod 148° Viewing Frame Front **Axon View** Viewing Frame Side 1" 2'-4" 1/2" 3/8" 1/2" Cedar Water Interactive Front Elevation

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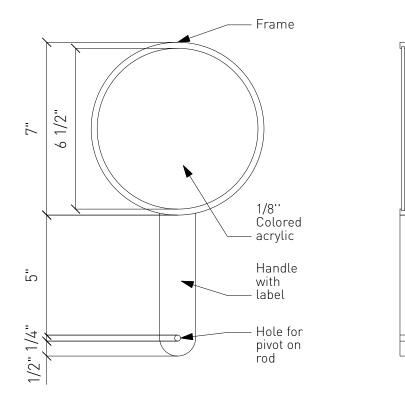
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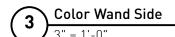
Cedar Water Interactive




Color Wand Plan



Color Wand Detail



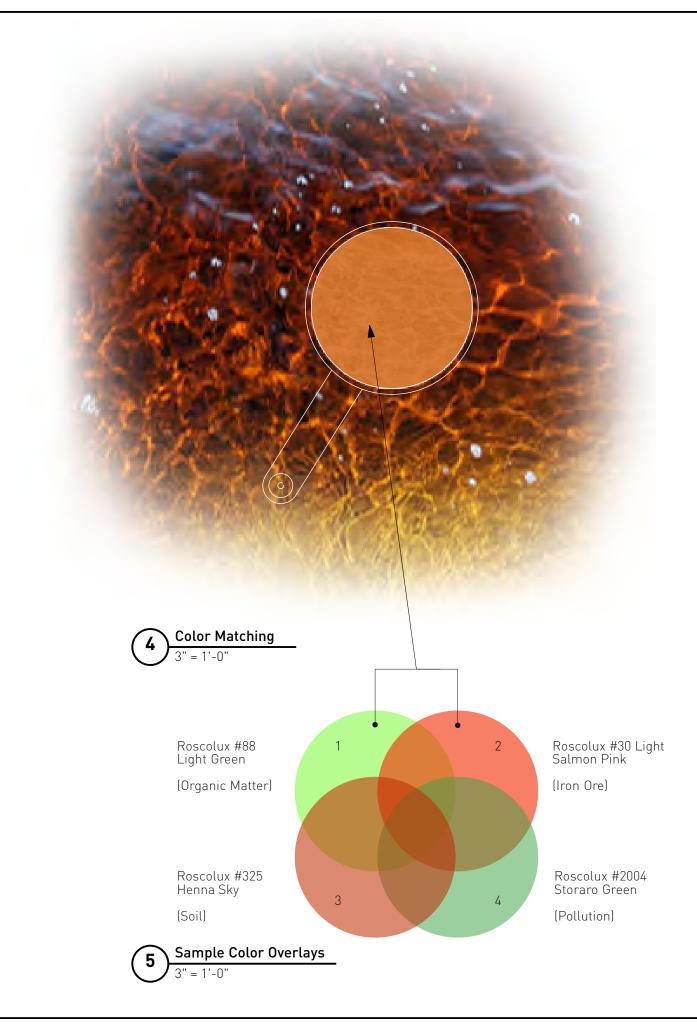

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Drawn by:

Cedar Water Interactive

Area 6 Pinelands Resources

This is a sculpture which represents all that has been produced from natural resources as well as harvested. Where possible, durable tactile elements that are actual artifacts, such as a historic mason jar reproduction will be used, as well as scenic elements such as the sand pile. The tree will have elements pinned off it and the upper level will have scenically reproduced branches and needles. The contractor will install an edge illuminated graphic in a recessed ceiling space, [graphic element 6.6].

The charcoal pile will have a glowing ember located within the pile. Power will be located by the general contractor in the ceiling for the glowing ember charcoal effect (#13).

Shop Mock Up

The exhibit contractor will create a massing model prototype for review.

Key

1. Bog Iron 13. Charcoal

2. Iron Pot 14. Charcoal (inner)

3. Iron Ingot or sprue 15. Cedar Tree

4. Tombstone 16. Cedar Planks

5. Cannonball (4lb & 6lb) 17. Wooden Shingles

18. Duck Decoys (Progressive - 3 Steps) 6. Section of Pipe

7. Fireback 19. Sphagnum Moss

8. Sand Pile 20. Crates

9. Mason Jar 21 Cranberries


10. Glass Paperweight 22. Cranberry Scoop


11. Slag 23. Jersey Devil


12. Jersey Glass




See sheet 6.3 for further details regarding the resource details

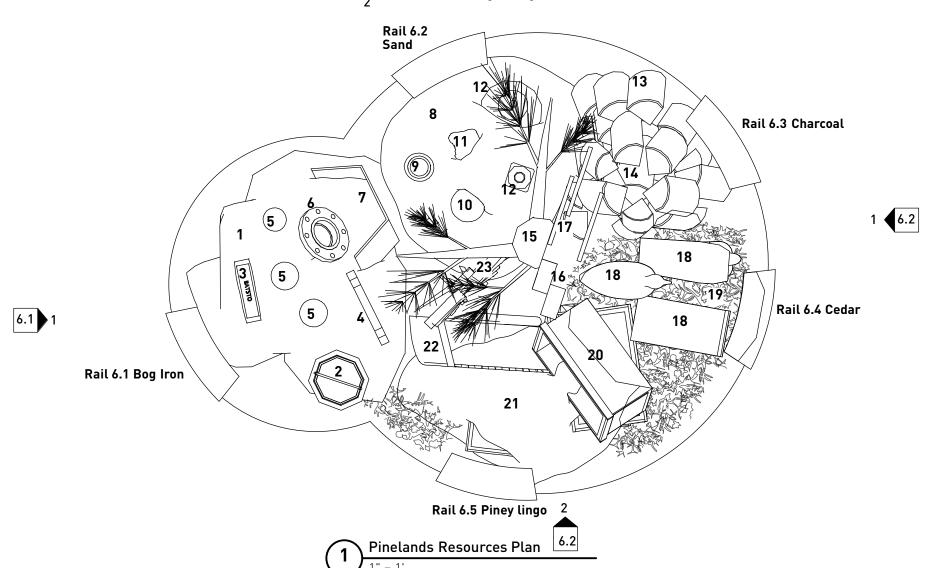

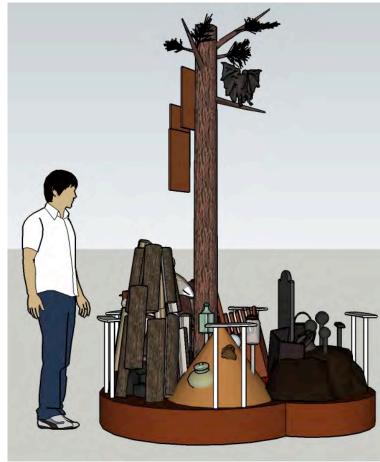

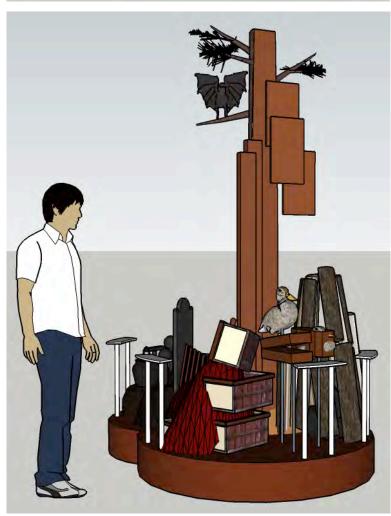

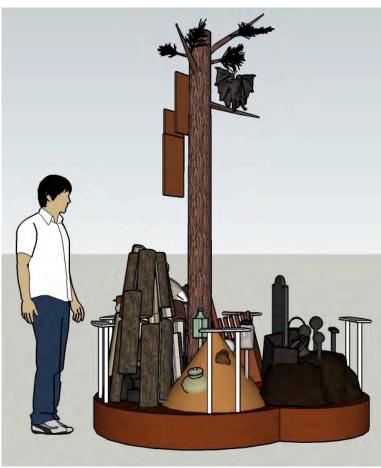



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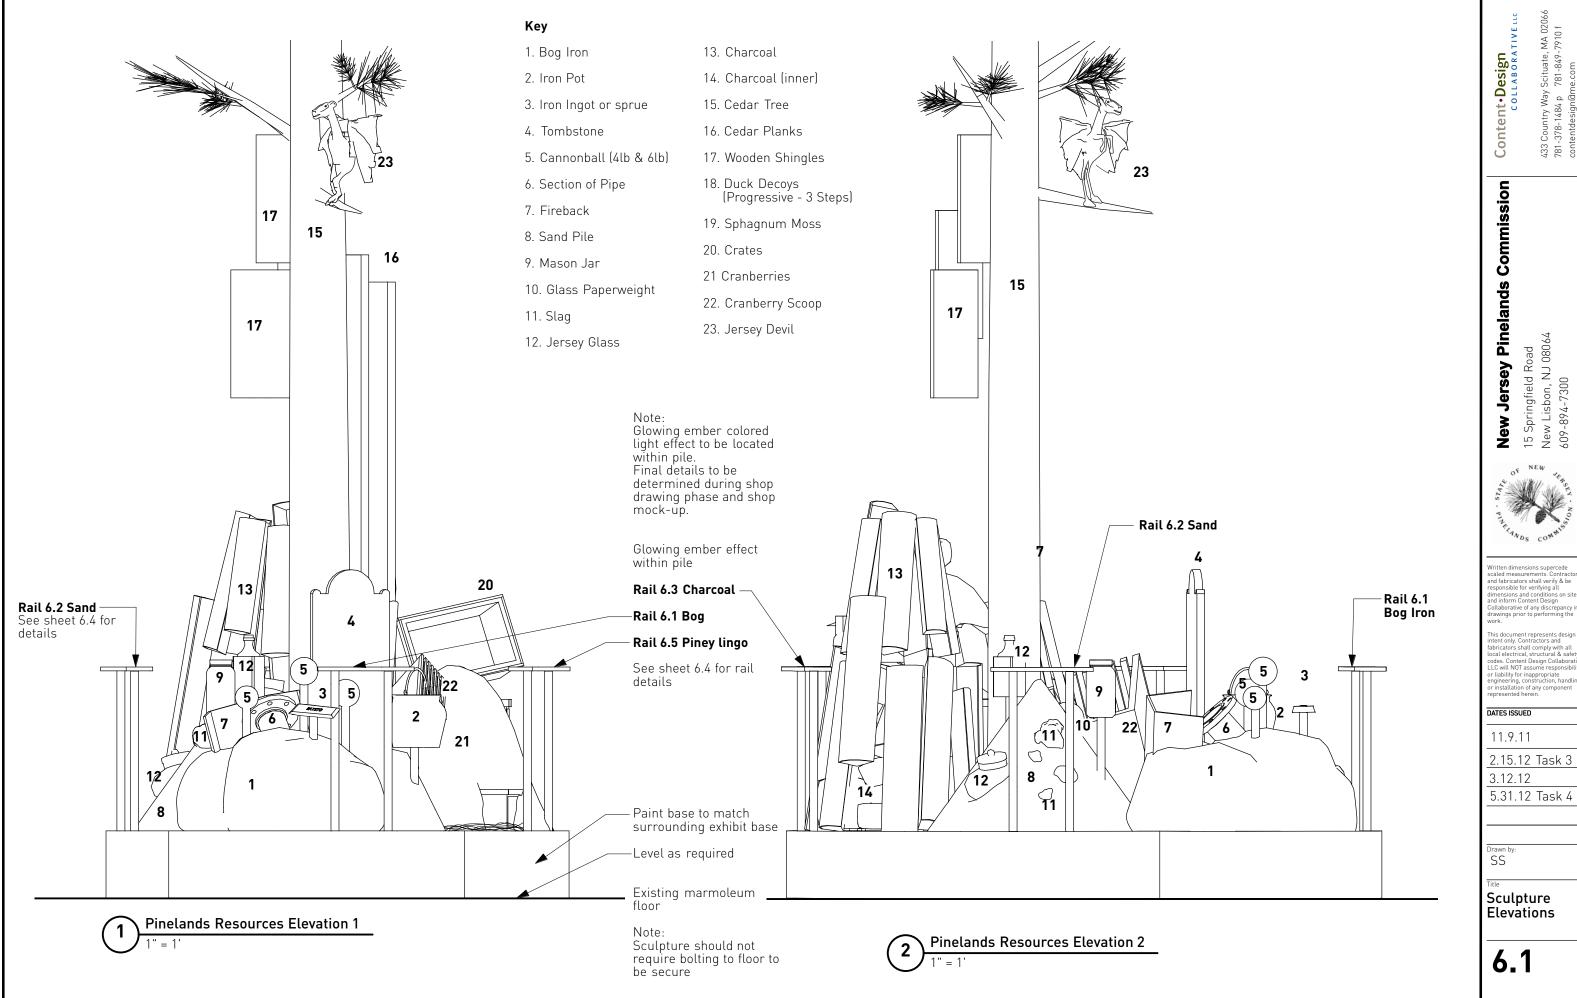
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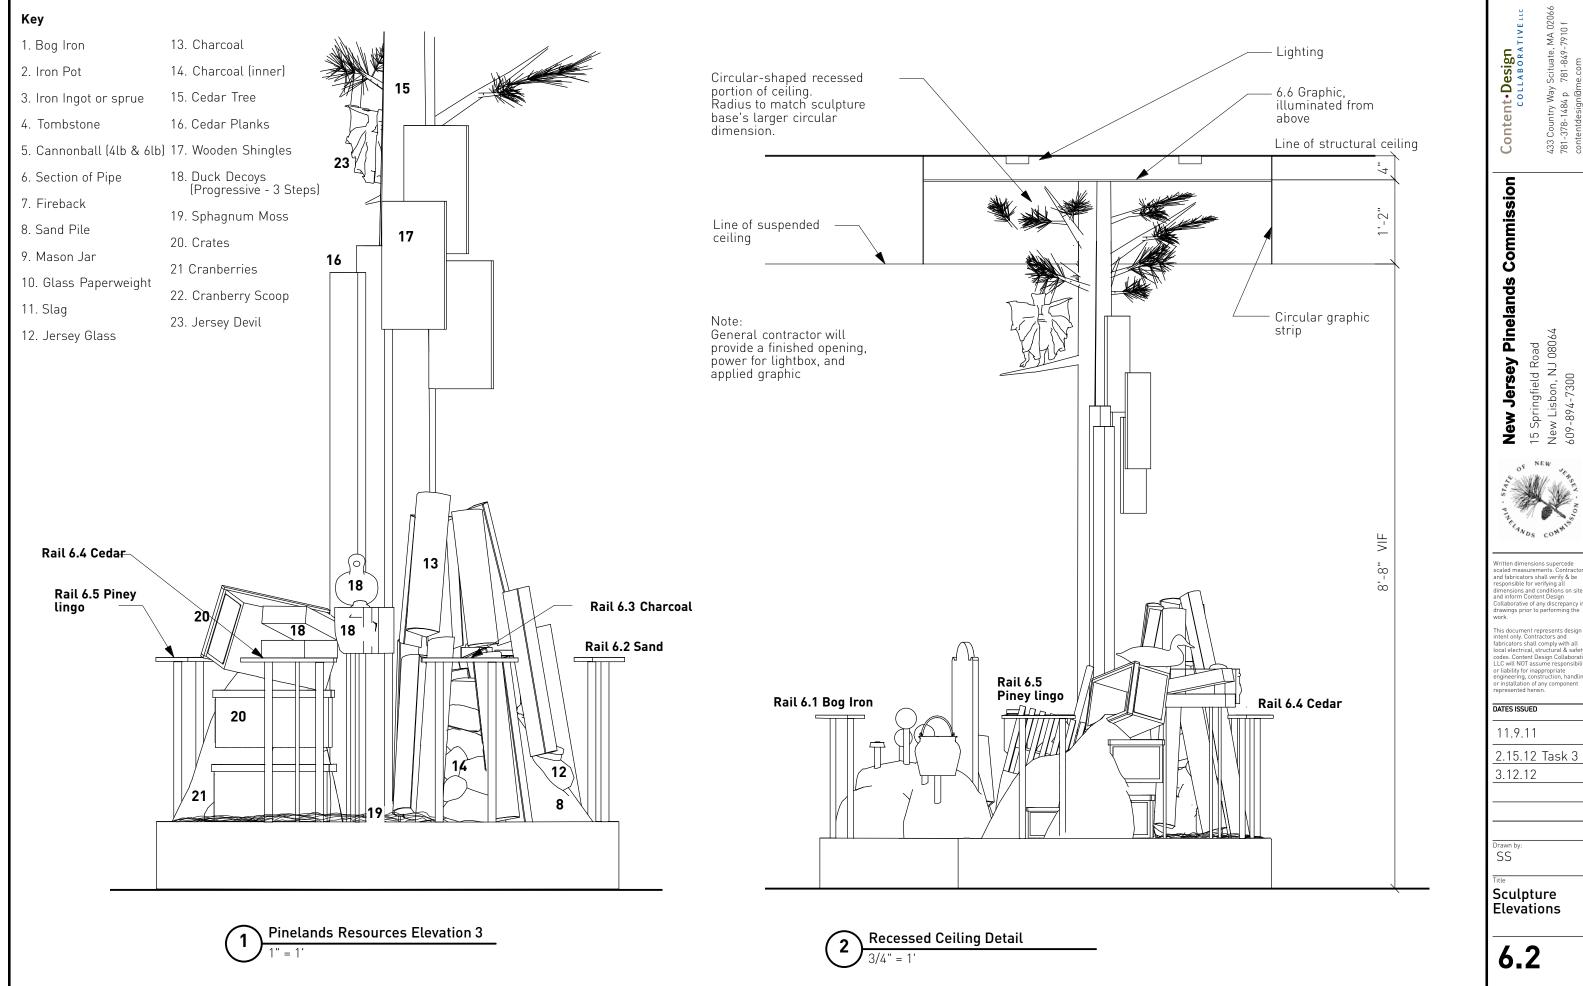
3.12.12

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Pinelands Resources Plan







1. Bog Iron

Obtain actual bog iron from the area. Clean to remove bacteria and spray with a matte polyurethane clear-coat to reduce dust.



2. Iron pot

Use existing iron pot, clean and finish as above. Modify to allow for support that raises pot above bog iron.



3. Iron ingot or sprue

To be provided by client during shop drawing phase

4. Tombstone

Fabricate to match existing tombstone (unless actual specimen can be sourced)



5. Cannon ball (4lb and 6lb)

Fabricate from resin and mount on acrylic rod (unless actual specimen can be sourced)



6. Section of Pipe

7. Fire Back



8. Sand pile

Replicate actual sand pile matching the fine sand used in glassmaking



9. Mason Jar

Purchase and mount replica 19th century mason jars (Old Sturbridge Village)



10. Glass Paper Weight

11. Slag

12. Jersey Glass



13. Charcoal

Use act pine segments, seal with matte polyurethane spray. Construct so outer log segments are lifting away to reveal darkened charcoal within.



14. Charcoal (inner)

Use actual 'lump charcoal' available for purchase. Create glowing ember effect within pile.

15. Cedar Tree

Typical scenic representation of cedar tree trunk

16. Cedar Planks

Finish actual cedar to resist staining, use rods and bolts to stand away from cut cedar trunk


17. Wooden Shingles

Finish with matte clearcoat to resist staining, mounted with pins to create dynamic effect of standing away from cedar tree

18. Duck Decoys (Progressive -3 Steps) Step 1: Rough blocks of cedar wood, hollowed center



Step 2: Partially carved decoy

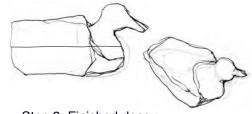

Step 3: Finished decoy



19. Spagnum Moss



20. Crates

To be provided by client during shop drawing phase

21. Cranberries



22. Cranberry Scoop



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Written dimensions supercede scaled measurements. Contracts and fabricators shall verify & be responsible for verifying all dimensions and conditions on sid and inform Content Design Collaborative of any discrepancy drawings prior to performing the

Inis accument represents designinent only. Contractors and fabricators shall comply with all local electrical, structural & safe codes. Content Design Collabora LLC will NOT assume responsibior liability for inappropriate engineering, construction, handl or installation of any component represented herein.

DATES ISSUED


11.9.11

2.15.12 Task 3


3.12.12

Drawn by:

Object Reference Key

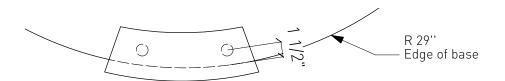


Graphic Rail Plan

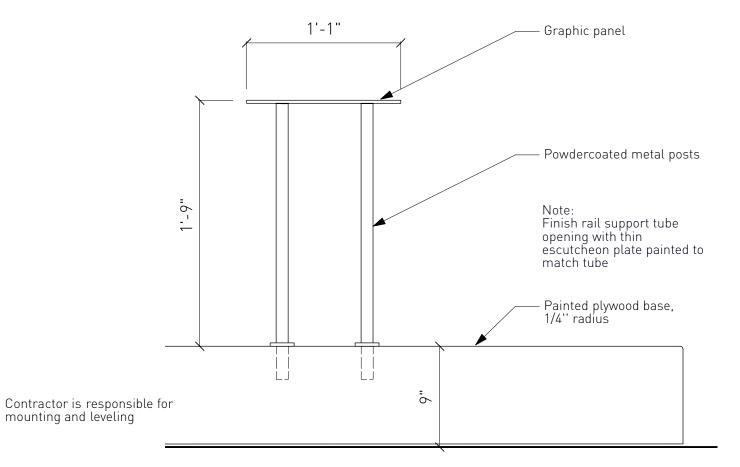


Graphic Rail Front Elevation

mounting and leveling

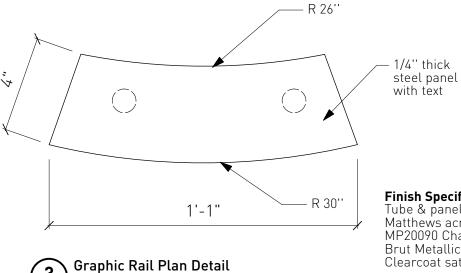

Finish Specifications
Tube & panel painted Matthews acrylic poly. MP20090 Champagne Brut Metallic Clearcoat satin finish

Text silkscreen color Matthews acrylic poly. MP11705 Chocolate Thunder

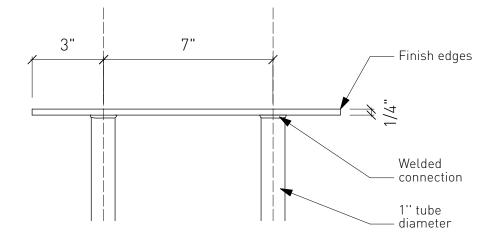

Graphic Rail Front View Detail

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written dimensions supercede scaled measurements. Contractor and fabricators shall verify & be responsible for verifying all dimensions and conditions on site and inform Content Design Collaborative of any discrepancy in drawings prior to performing the work.

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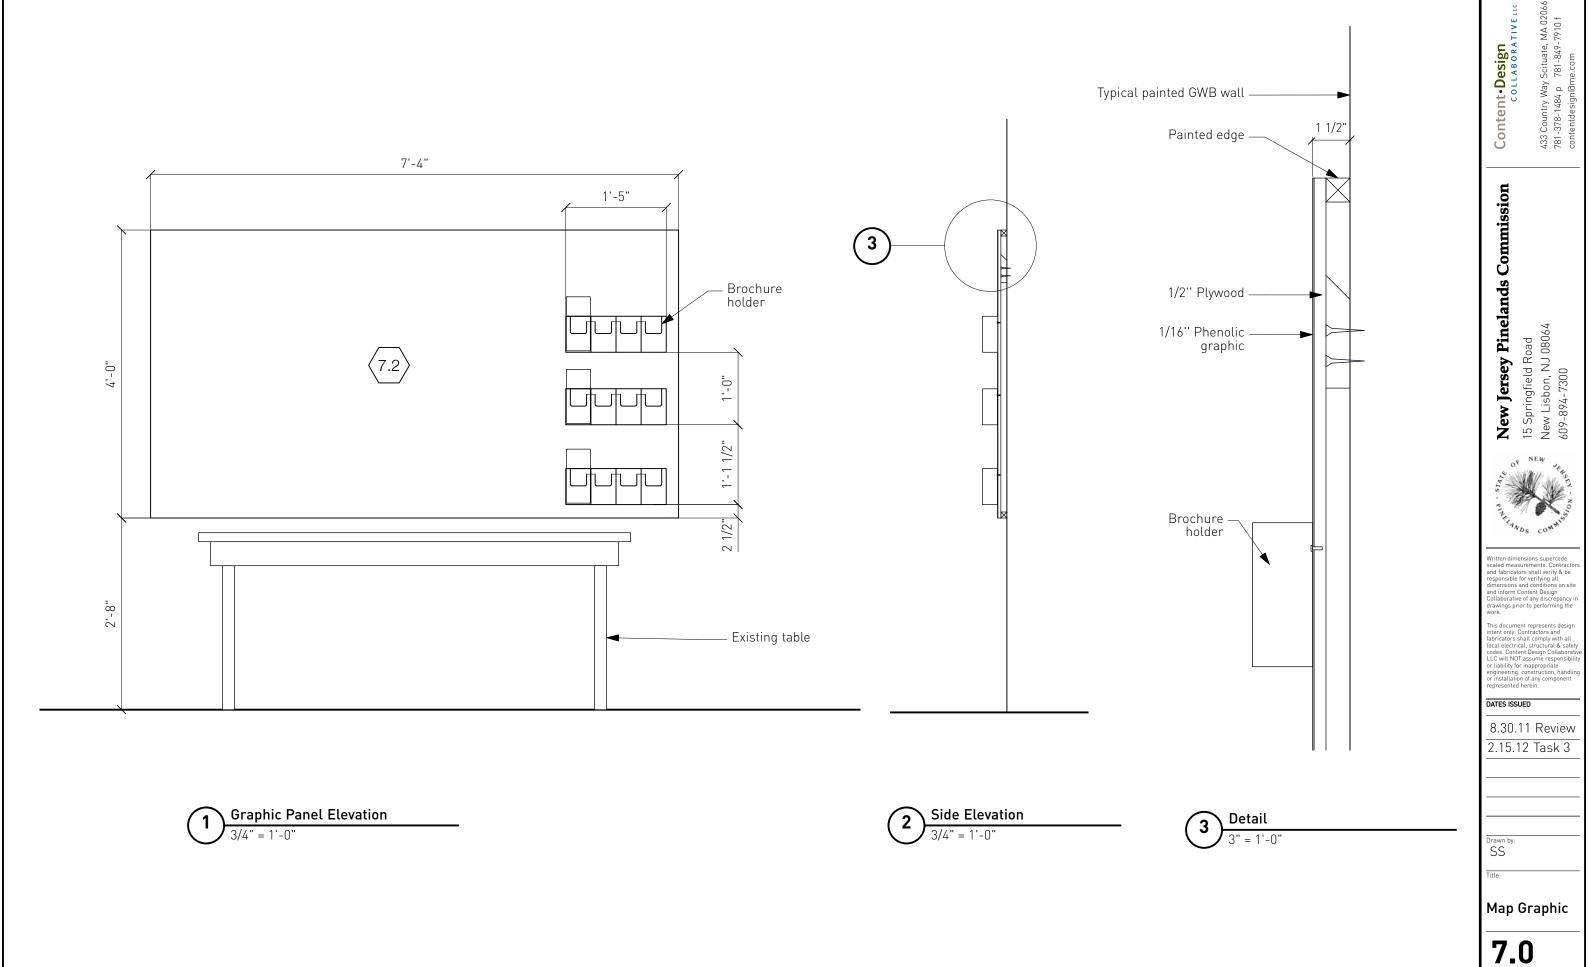
2.15.12 Task 3


3.12.12

5.31.12 Task 4

Drawn by:

Graphic Rail Details



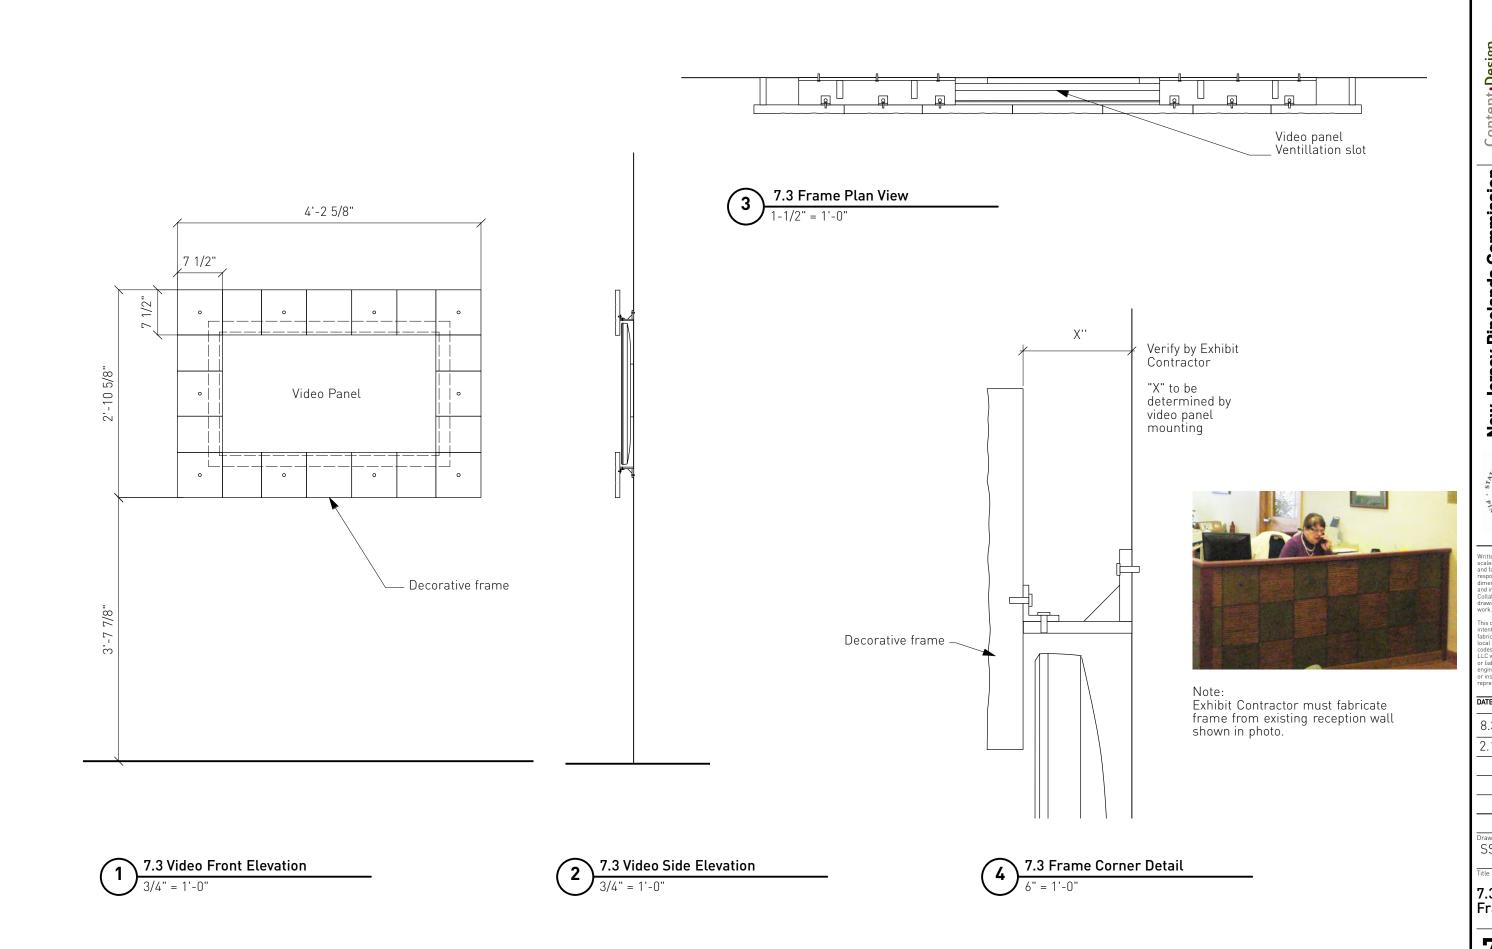

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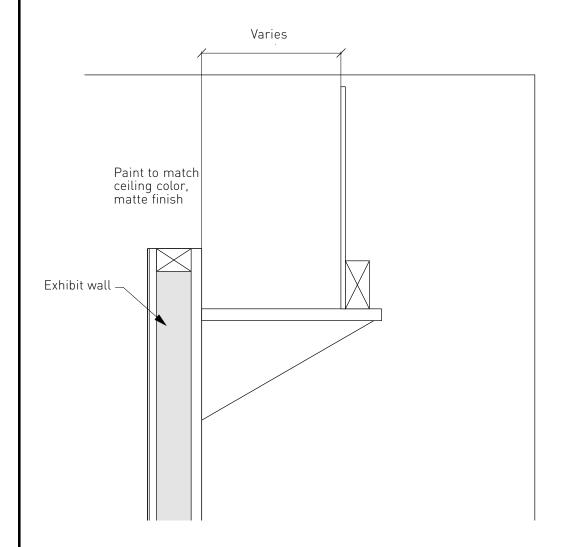


DATES ISSUED

8.30.11 Review 2.15.12 Task 3

Drawn by:

7.3 Video & Frame



Baffle Detail 1" = 1'-0"

3.5 Serotiny Video

Visitor Control	Playback	Signal Process	Output Device
Proximity switch	Playback device	Amplifier	Video Panel Speaker

Product List

Qty	Mfg.	Model	Description
1	Meyer Sound	UP-4XP	Ultra compact speaker
1	ViewSonic	VFM1035-52	Video playback
2	Dakota Sound		Mounting U-bracket
1	Alcorn McBride	AM4/E	Solid state player w/ ethernet
1	Bogen	ANS501	Ambient noise sensor and microphone
1	Museum Tech.	BB-150	Motion detector with power supply

Visitor Control	Playback	Signal Process	Output Device
Proximity switch	Playback device	Amplifier	Video Panel Speaker

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2.15.12 Task 3


5.31.12 Task 4 6.14.12 Spkr.

Drawn by:

General Details

Renderings

8.1

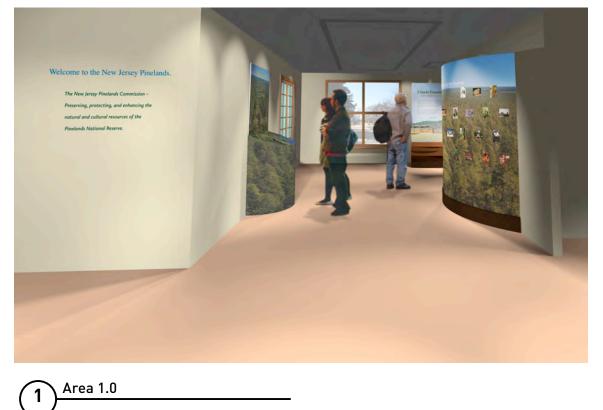





Area 2.0 Detail

2 Area 2.0



Area 3.0, 4.0, 6.0 Sculpture



Area 4.0, 5.0/1.2